VILLAGE OF SUSSEX SUSSEX, WISCONSIN

Minutes of the Architectural Review Board (ARB) meeting held on July 8, 2020.

Assistant Development Director Kasey Fluet called the meeting to order at 4:02 p.m.

Due to the absence of Anthony LeDonne, Fluet asked the members to appoint a Chair Person Pro Tem, a motion from Foxe, seconded by Zoellick to appoint Melissa Granicki Chair Person Pro Tem for this meeting.

Motion carried.

Members present: Greg Zoellick, Gary Foxe, Melissa Granicki and Mike Knapp (arrived at 4:05p.m.).

Members absent: Anthony LeDonne

Others present: Kasey Fluet, Assistant Development Director (ADD).

Consideration and possible action on the minutes of June 3, 2020.

A motion by Foxe, seconded by Zoellick to approve the minutes of the meeting held on June 3, 2020.

Motion carried.

Consideration and possible action on a site plan, lighting plan, landscape plan and sign plan for Dunkin'/Baskin Robbins W249N6478 STH 164.

Nikoletta Scarlatis architect for the project was present for this matter.

Fluet reviewed memo (copy attached) starting with the site plan. Foxe asked why the site only had one handicap stall and Taco Bell has two. Fluet stated the code only requires one. Foxe stated the sidewalks should have ramps for easy pedestrian access.

Site – it was consensus of the ARB an additional handi cap stall should be added to the site and a ramp added to the east pedestrian way sidewalk.

Scarlatis present the materials to be used on the building. The lannon stone will also be used on the monument sign (see photo attached).

Architecture – It was the consensus of the ARB the architecture plan meets the requirements.

Lighting – It was the consensus of the ARB the lighting plan meets the requirements.

Landscape – It was the consensus of the ARB the landscape plan meets the requirements.

Sign- It was the consensus of the ARB the sign plan meets the requirements.

A motion by Granicki, seconded by Foxe to approve the site, architectural, lighting, landscape and sign plans for Dunkin'/Baskin Robbins W249N6478 STH 164 with the following conditions:

- Add a second handicap stall to the site.
- Add a ramp at the east parking lot pedestrian way.

Motion carried.

Consideration and possible action on an outdoor patio landscape plan for Tequila Restaurant and Beer Garden establishments at Mammoth Springs at The Corners N63W23675 Main Street.

Arthur Sawall owner of building was present for this matter.

Fluet reviewed memo (copy attached). Sawall reviewed the site plan and presented a photo of the hydrangea bush to be planted along the patio. Zoellick stated he did not like a white bloom variation of the plant.

A motion by Granicki, seconded by Foxe to approve the hydrangea bushes to be used for the landscape screening around the patio, color of blooms should be any color other than white.

Motion carried.

<u>Consideration and possible action on Mammoth Springs at The Corners master sign plan</u> for retail tenant spaces N63W23675 Main Street.

Arthur Sawall owner of building was present for this matter.

Fluet reviewed the memo (copy attached). Sawall reviewed the master sign plan (copy attached). Sawall stated he had a sign company draft the plan. Sawall pointed out it is important to have a sign plan to give to potential tenants. The signs will be face illuminated and not externally lit, all signs will have steady illumination.

A motion by Granicki, seconded by Foxe to approve the master sign plan for Mammoth Springs at The Corners N63W23675 Main Street.

Motion carried.

A motion by Granicki, seconded by Zoellick to adjourn the meeting at 4:57 p.m.

Motion carried.

Respectfully submitted, Kasey Fluet, Assistant Development Director



N64W23760 Main Street Sussex, Wisconsin 53089 Phone (262) 246-5200 FAX (262) 246-5222

Email: info@villagesussex.org Website: www.villagesussex.org

MEMORANDUM

TO: Architectural Review Board

FROM: Kasey Fluet, Assistant Development Director

RE: ARB meeting for July 8, 2020

DATE: July 1, 2020

The following is background information for the ARB agenda items. Please refer to the Design Standards dated March 25, 2014.

I. Roll call.

II. Consideration and possible action on the ARB minutes from the June 3, 2020 meeting.

III. Consideration and possible action on the site plan, architectural plan, lighting plan, landscape plan and sign plan Dunkin'/Baskin Robbins (W249N6478 STH 164).

This site is zoned B-2. The restaurant with drive through is permitted in the B-2 Regional Business District in accordance with Section 17.0417 (A)(1)(b) subject to the Plan Commission must find that the vehicle stacking will not impact surrounding properties or any public roadway. Dunkin'/Baskin Robbins is a franchise chain to offer drive through and in stores service for the Dunkin' brand items. The Baskin Robbins will be in store service and some menu items available at the drive through. Hours of operations will be Monday through Sunday 4:00 a.m. to 12:00 a.m. The store size will be 1,835 square feet, the following are comments for the plans:

Site

- Stacking for drive through accommodates 7 cars with no impact to surrounding properties or public roadway.
- Provides good pedestrian orientation.
- Need to provide more details about proposed monument sign location.
- There is sufficient parking with 27 stalls.

Architecture

- Building meets height and required setbacks.
- Dumpster enclosure material to match building.
- Roof top units are to be screened from view.
- Material to be used meets the Design Standards.

Lighting

- Lighting must not spill out onto neighboring properties.
- Pole height not to exceed 25 feet, bases are to be buried or if exposed they shall be painted to blend in with the surroundings or have a decorative base.

• Light poles to match or be similar to poles and height of Taco Bell.

Landscape

• The landscape plan meets the Design Standards; 18 trees and 148 shrubs/flowers.

Signage

- Meets the code requirements.
- Monument sign meets the Design Standards.

The plans will be reviewed at the July Architectural Review Board. The site plan does encroach in the southeast corner on the adjacent undeveloped lot. A CSM or quit claim between the properties needs to occur to square off the lot as proposed.

Policy Question:

1. Are there any concerns with the various plans?

Action Items:

1. Act on the plans.

<u>Staff Recommendation:</u> Staff recommends the ARB approve the site, architectural, lighting, landscape and sign plans for Dunkin'/Baskin Robbins new building subject to any conditions.

III. Consideration and possible action on an outdoor patio landscape plan for Tequila Restaurant and Beer Garden establishments at Mammoth Springs at The Corners N63W23675 Main Street.

The plan of operations for both establishments has been approved by the Plan Commission and the use of Old Brooke Square has been approved by the Park and Rec Board. The ARB was directed to review the landscape plan for the outdoor patio to determine if the landscaping shown is a sufficient buffer to provide areas of designation for the consumption of alcoholic beverages. We don't want to screen the view from Main Street for public safety, but make it obvious where alcohol can be served and where general park users can utilize the park and access the bugline trail.

Policy Ouestion:

1. Are there any concerns with the outdoor patio landscape plan?

Action Items:

1. Act on the plan.

Staff Recommendation: Staff recommends the ARB approve the outdoor patio landscape plan for Mammoth Springs at The Corners subject to any conditions.

IV. Consideration and possible action on Mammoth Springs at The Corners master sign plan for retail tenant spaces N63W23675 Main Street.

It is recommended each landlord of multi-tenant buildings submit a master sign plan for their complex in order to expedite the sign approval process for a new tenant. The master sign plan is used as a guideline for potential tenants and the building inspector when reviewing sign permit applications.

The ARB should review the plan and determine if it meets the Design Standards.

Policy Question:

1. Are there any concerns with the Master sign plan?

Action Items: 1. Act on 1

Act on the plan.

Staff Recommendation: Staff recommends the ARB approve the master sign plan for Mammoth Springs at The Corners subject to any conditions.


PROPOSED

DUNKINO

baskin BR tobbins

W249 N6478, STH-164 **VILLAGE OF SUSSEX, WISCONSIN SCARLATIS JOB # 202006**



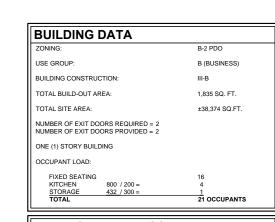

SHEET NUMBER	SHEET NAME
T-1	TITLE SHEET
SP-1	SITE PLAN
SP-1.1	SITE DETAILS
SP-1.2	SIGNAGE DETAILS
SP-1.3	SITE DETAILS
SP-2	PHOTOMETRIC PLAN
SP-3	SETBACK SITE PLAN
L-1	LANDSCAPE PLAN AND DETAILS
A-1.0	FLOOR PLAN
A-1.1	BUILDING SIGNAGE
A-5.1	EXTERIOR ELEVATIONS
A-5.2	EXTERIOR ELEVATIONS

NICK SCARLATIS & ASSOCIATES, LTD.

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NOTES:

06/08/2020	PLAN COMMISSION SUBMITTA
05/27/2020	PLAN COMMISSION REVIEW

NEW CONSTRUCTION

DUNKIN' BR COMBO

W249 N6478, STH-164 VILLAGE OF SUSSEX, WI

TITLE SHEET

Scale: AS SHOWN Sheet Number:

Project No.

Drawn: MH T-1.0 202006

CONTACTS

OWNER/DEVELOPER


THE KARDO GROUP, INC.

KARDO RASHA 3209 YORK RD OAK BROOK, ILLINOIS 60523 TEL 847-6686842 kardo.rasha@gmail.com


ARCHITECT/ENGINEER

NICK SCARLATIS & ASSOCIATES, LTD.


5405 WEST 127TH STREET CRESTWOOD, ILLINOIS 60418 TEL 708.653.5200 FAX 708.653.5202 EMAIL: nick@scarlatis.com

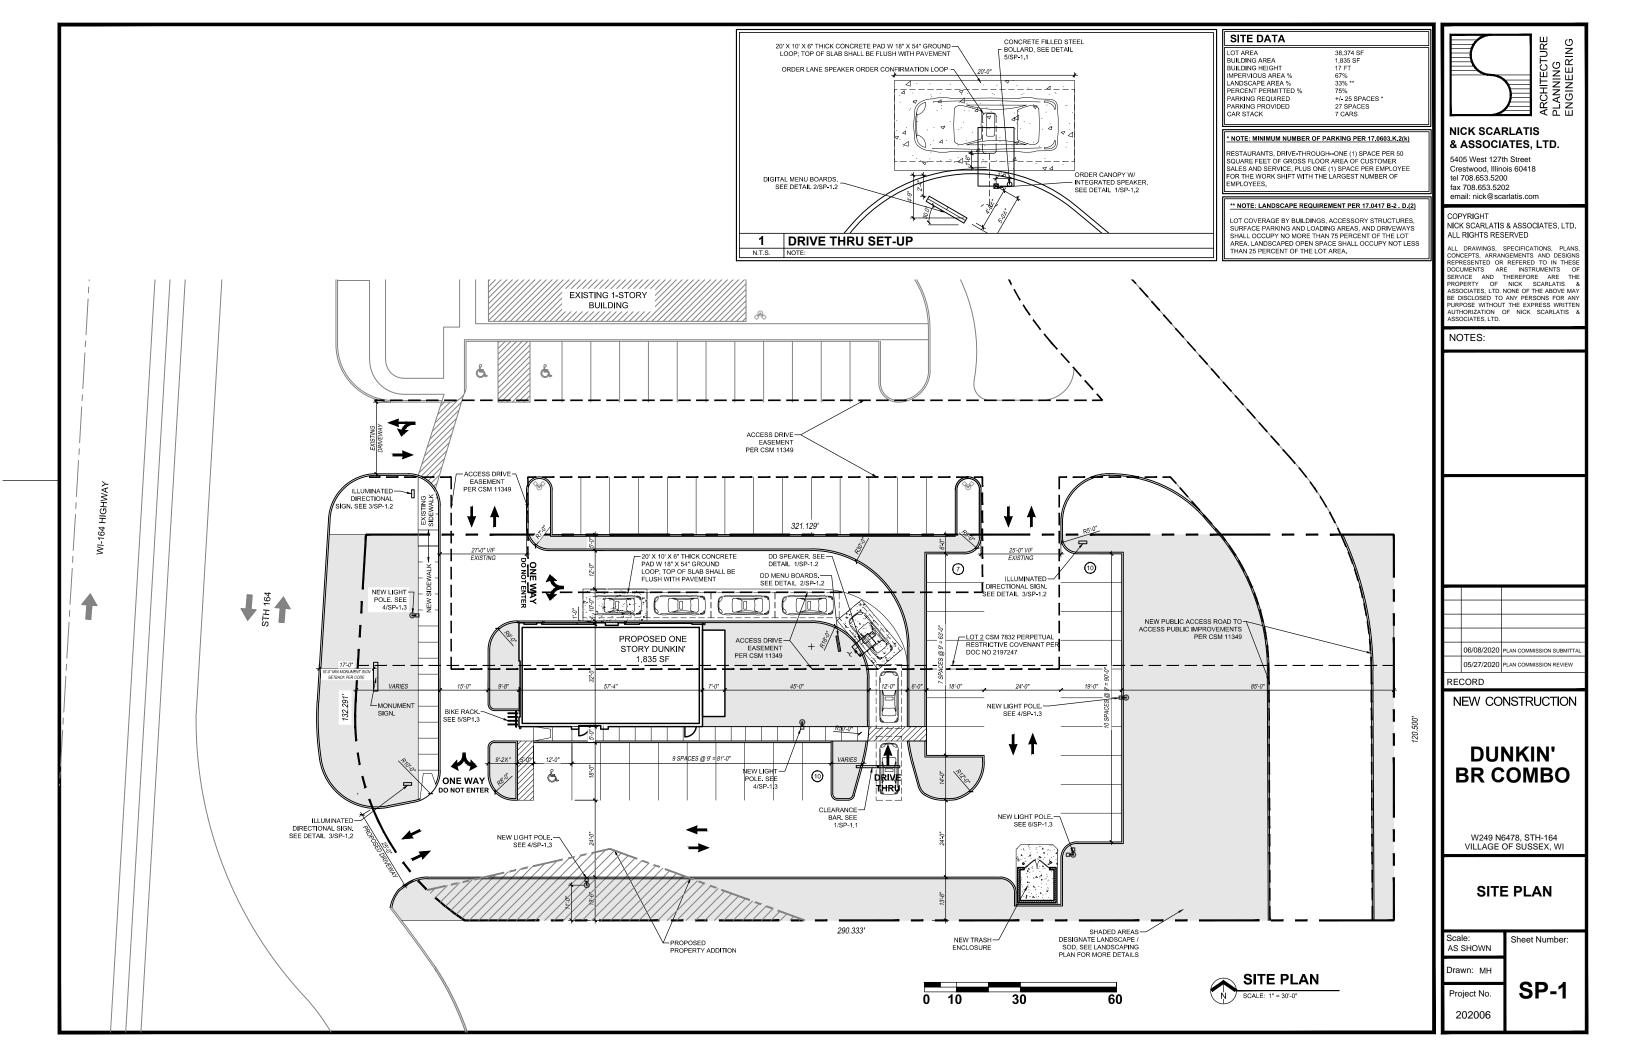

ATEGORY	CODE	MATERIAL	MANUFACTURER	PRODUCT #	DESCRIPTION / REMARKS
01 ONCRETE FINISH	PS-01 LP	FIBER CEMENT PANEL	JAMES HARDIE	CONCRETE FINISH	COLOR:"PEARL GRAY" SURFACE: REVEAL PANEL DIMENSION: (48"X96"PANEL)
	PS-02	FIBER CEMENT SIDING	JAMES HARDIE	CHARCOAL FINISH	COLOR:"IRON GRAY" SURFACE: HARDIE SIDING DIMENSION: 71/4" X 12' X 5/16" THK WITH 6" SIDDING EXPOSURE
	PS-02 LP	FIBER CEMENT PANEL	JAMES HARDIE	CHARCOAL FINISH	COLOR:"IRON GRAY" SURFACE: REVEAL PANEL DIMENSION: (48"X96"PANEL)
02 CHARCOAL FINISH	BR-02	THIN BRICK	ENDICOTT BRICK	CHARCOAL FINISH	(CREATIVE MATERIALS PRODUCT) "MANGANESE IRON SPOT" 2 1/4" (H) x 7 5/8" (W) x 5/8" (THK) SMOOTH MAPEI ULTRAFLEX LFT #10 "BLACK" OR EIFS-06
		PAINTED COATING	MATTHEWS PAINT	CONCRETE FINISH	COLOR: MP10269 DARK SLATE FINISH LVS SATIN V2.0
	PC-02	PAINTED COATING	SHERWIN WILLIAMS	CONCRETE FINISH	SW 7069 "IRON ORE"
		PAINTED COATING	POWDER COAT	CONCRETE FINISH	SW 7069 "IRON ORE"
03 WOOD PATTERN	PS-03	FIBER CEMENT SIDING	WOODTONE	WOOD FINISH RUSTIC SERIES WOODTONE	COLOR: "HONEY GLAZE" WOOD PATTERN SURFACE: WOOD PATTERN PLANK DIMENSION: 7 1/4" X 12' X 5/16" THK WITH 6" SIDDING EXPOSURE NOTE: NAILS TO MATCH WOOD FINISH
	PS-04 LP	FIBER CEMENT PANEL	JAMES HARDIE	OFF WHITE FINISH LARGE FORMAT PANEL	COLOR:"COBBLESTONE" SURFACE: REVEAL PANEL DIMENSION: (48"X96"PANEL)
04 OFF WHITE		PAINTED COATING	MATTHEWS PAINT	OFF WHITE FINISH	COLOR MATCH PMS COOL GREY 1C MAP ULTRA LOW V.O.C.
FINISH PC-04		COATING		OFF WHITE FINISH	SW 7063 "NEBULOUS WHITE"
		PAINTED COATING	POWDER COAT	OFF WHITE FINISH	SW 7063 "NEBULOUS WHITE"
05 MID-TONE	PS-05	PS-05 FIBER CEMENT JAMES HARDIE		MID-TONE FINISH	COLOR: "GRAY SLATE" SURFACE: HARDIE SIDING DIMENSION: 71/4" X 12' X 5/16" THK WITH 6" SIDDING EXPOSURE
FINISH	PS-05 LP	FIBER CEMENT PANEL	JAMES HARDIE	MID-TONE FINISH	COLOR:"GRAY SLATE" SURFACE: REVEAL PANEL DIMENSION: (48"X96"PANEL)
09 LIGHT GREY	PTE-09	PAINT	SHERWIN WILLIAMS OR FACTORY FINISH TO MATCH SW COLOR	LIGHT GREY (WALK-IN BOX)	SW 7064 "PASSIVE"
12	PC-12	PAINTED COATING	MATTHEWS PAINT	DD PINK	COLOR MATCH PMS 219 C COLOR: MP79206 R161426 FINISH: LVS SATIN V1.0 OVER MP55898 WHITE BASECOAT
DD PINK	PC-12	PAINTED COATING	SHERWIN WILLIAMS	DD PINK	COLOR MATCH PMS 219 C
		PAINTED COATING	POWDER COAT	DD PINK	COLOR MATCH PMS 219 C
		PAINTED COATING	MATTHEWS PAINT	DD ORANGE	COLOR MATCH PMS 165C COLOR: MP797700 R161426 FINISH: LVS SATIN V1.0 OVER MP55898 WHITE BASECOAT
13 DD ORANGE	PC-13 PAINTED COATING		SHERWIN WILLIAMS	DD ORANGE	BLENDED AT: SHERWIN WILLIAMS PRODUCT: INISHES, LOWELL MA PRODUCT: LV3 - GENESIS LOW VOC SATIN GT1039 ORANGE TONER 755.97G / 19GAL GT1611 LOW VOC GLOSS CLEAR 529.21G / .12GAL GT1043 AUTUMN ORANGE 194.04G / .05GAI GT1011 ARTIC WHITE 137.20G / .02GAL GT1081 REDUCER 442.38G / .13GAL GT1510 LOW VOC FLAT CLEAR 2157.21G / .49GAL
		PAINTED COATING	POWDER COAT	DD ORANGE	COLOR MATCH PMS 165C

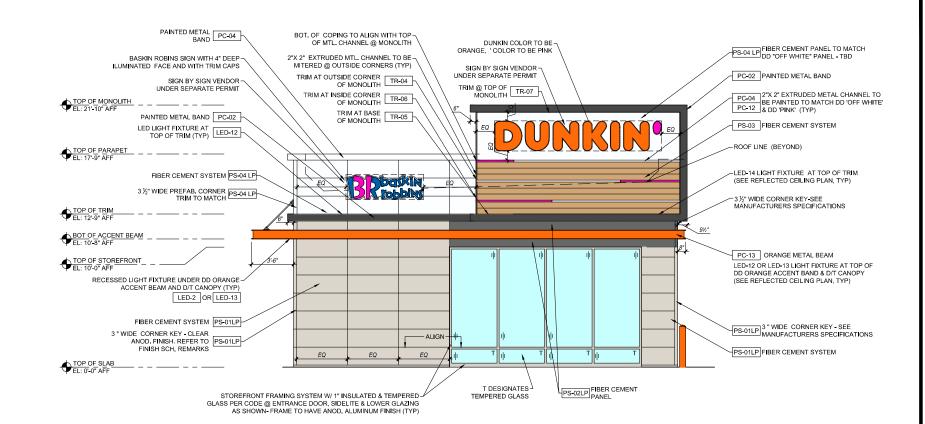

WEST ELEVATION

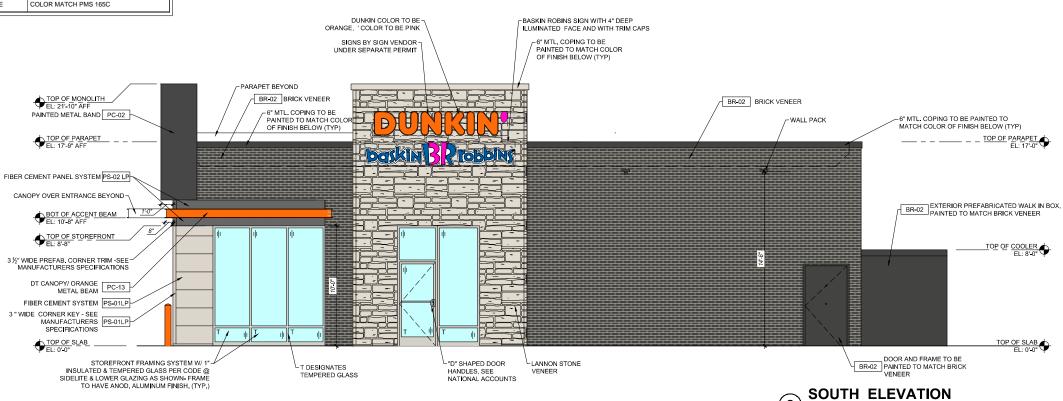



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NOTES:

06/08/2020	PLAN COMMISSION SUBMITTA
05/27/2020	PLAN COMMISSION REVIEW

RECORD

NEW CONSTRUCTION

DUNKIN' BR COMBO

W249 N6478, STH-164 VILLAGE OF SUSSEX, WI


EXTERIOR ELEVATIONS

Scale: Sheet Number: AS SHOWN


Drawn: MH


Project No. A-5.1

202006

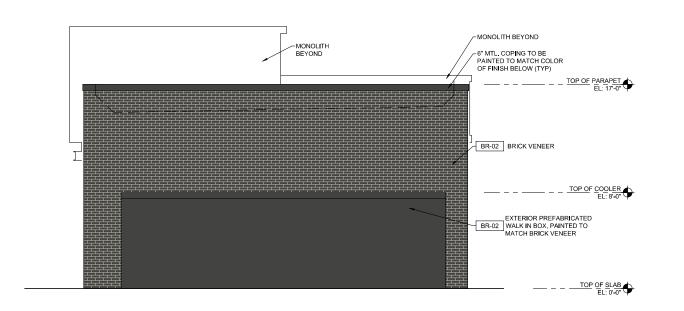



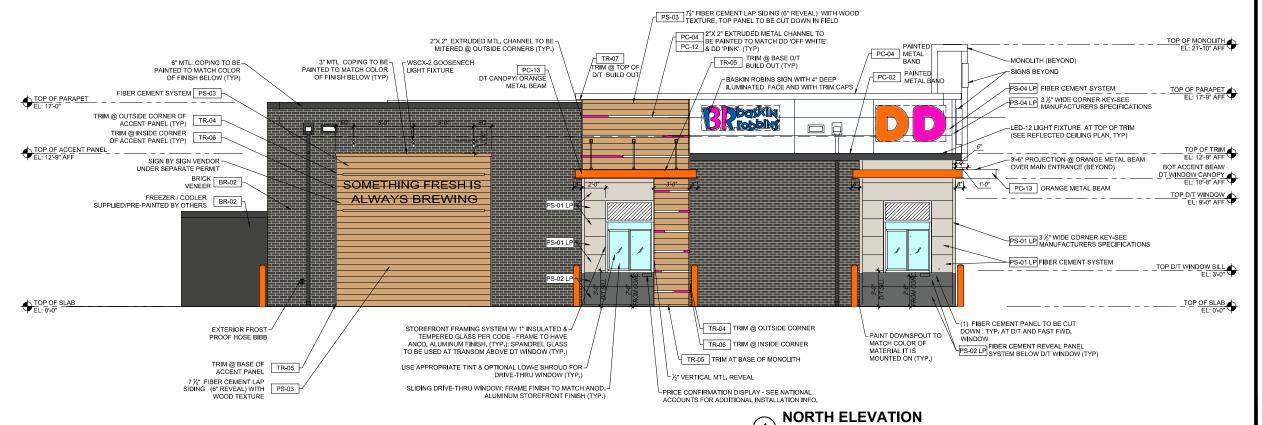

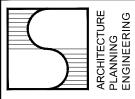

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05/27/2020	PLAN COMMISSION REVIEW

RECORD

NEW CONSTRUCTION


DUNKIN' BR COMBO

W249 N6478, STH-164 VILLAGE OF SUSSEX, WI

EXTERIOR ELEVATIONS

Scale: AS SHOWN	Sheet Number:
Drawn: MH	

Project No. **A-5.2**

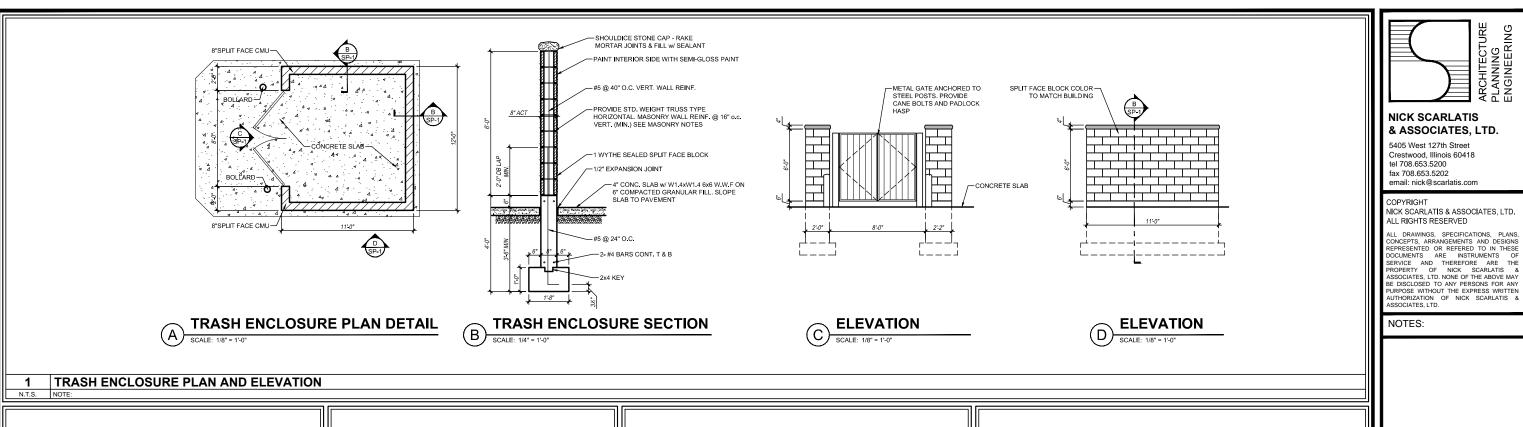

PARKING

COLOR: LEGEND AND BORDER: GREEN BACKROUND: WHITE WHITE SYMBOL ON BLUE BACKGROUND

NOTE: ALL HANDICAP STALLS ARE TO BE PAINTED BLUE

3 HANDICAP PARKING SIGN DETAIL

TRIANGULAR SHAPED PIECE OF PAVEMENT CAN BREAK OFF

DO

NOTE: THESE DETAILS ARE TO BE USED ONLY ON EXISTING INSTALLATIONS - USE PVC

CONDUIT AT ALL NEW


INSTALLATIONS

2 SAW CUT DETAILS

THRU GROUND LOOP

PAVEMENT

INSTALLATIONS IN EXISITING

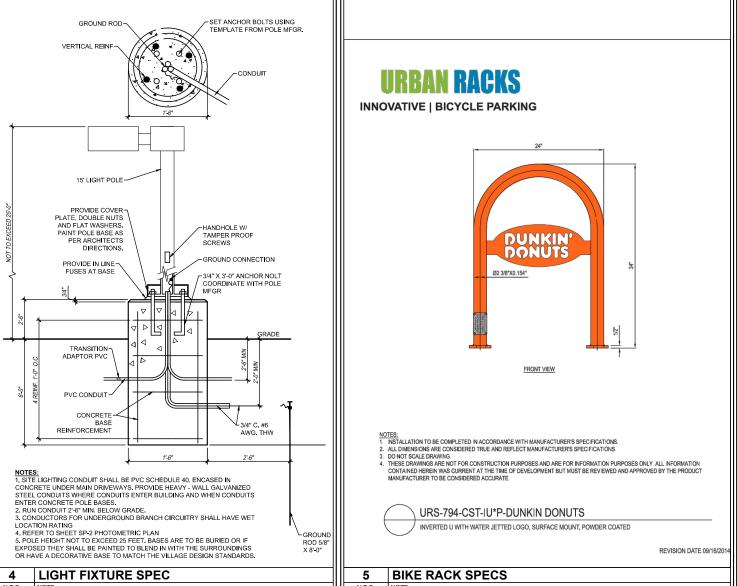

07/01/2020 SUBMITTED FOR ARB

RECORD

AS SHOWN

Drawn: MH

Project No.

202006

06/08/2020 PLAN COMMISSION SUBMIT

05/27/2020 PLAN COMMISSION REVIEW

NEW CONSTRUCTION


DUNKIN' BR COMBO

W249 N6478, STH-164 VILLAGE OF SUSSEX, WI

SITE DETAILS

Sheet Number:

SP-1.3

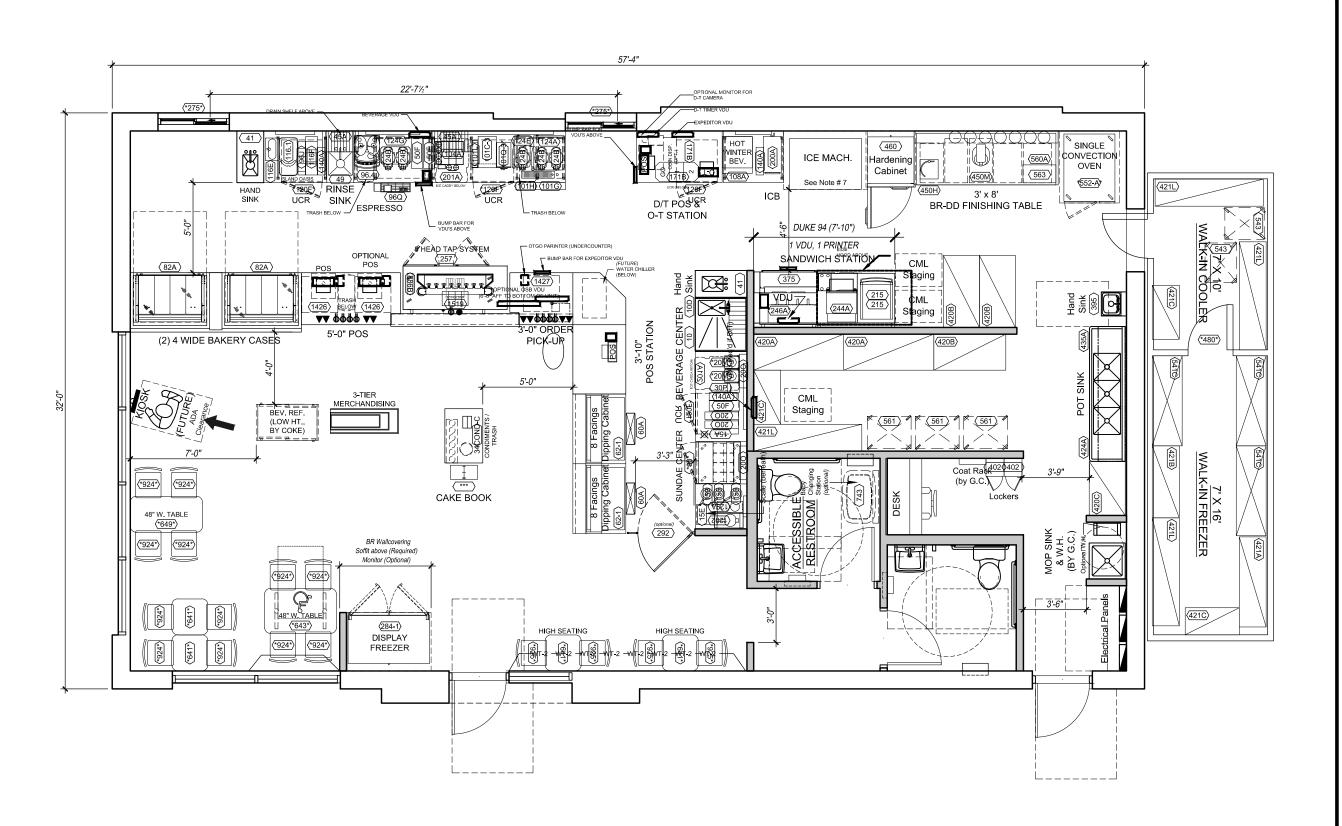



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05/27/2020 PLAN COMMISSION REVIEW

RECORD

NEW CONSTRUCTION

DUNKIN' BR COMBO

W249 N6478, STH-164 VILLAGE OF SUSSEX, WI


FLOOR PLAN


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Project No.

202006

A-1.0



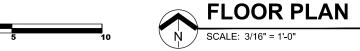

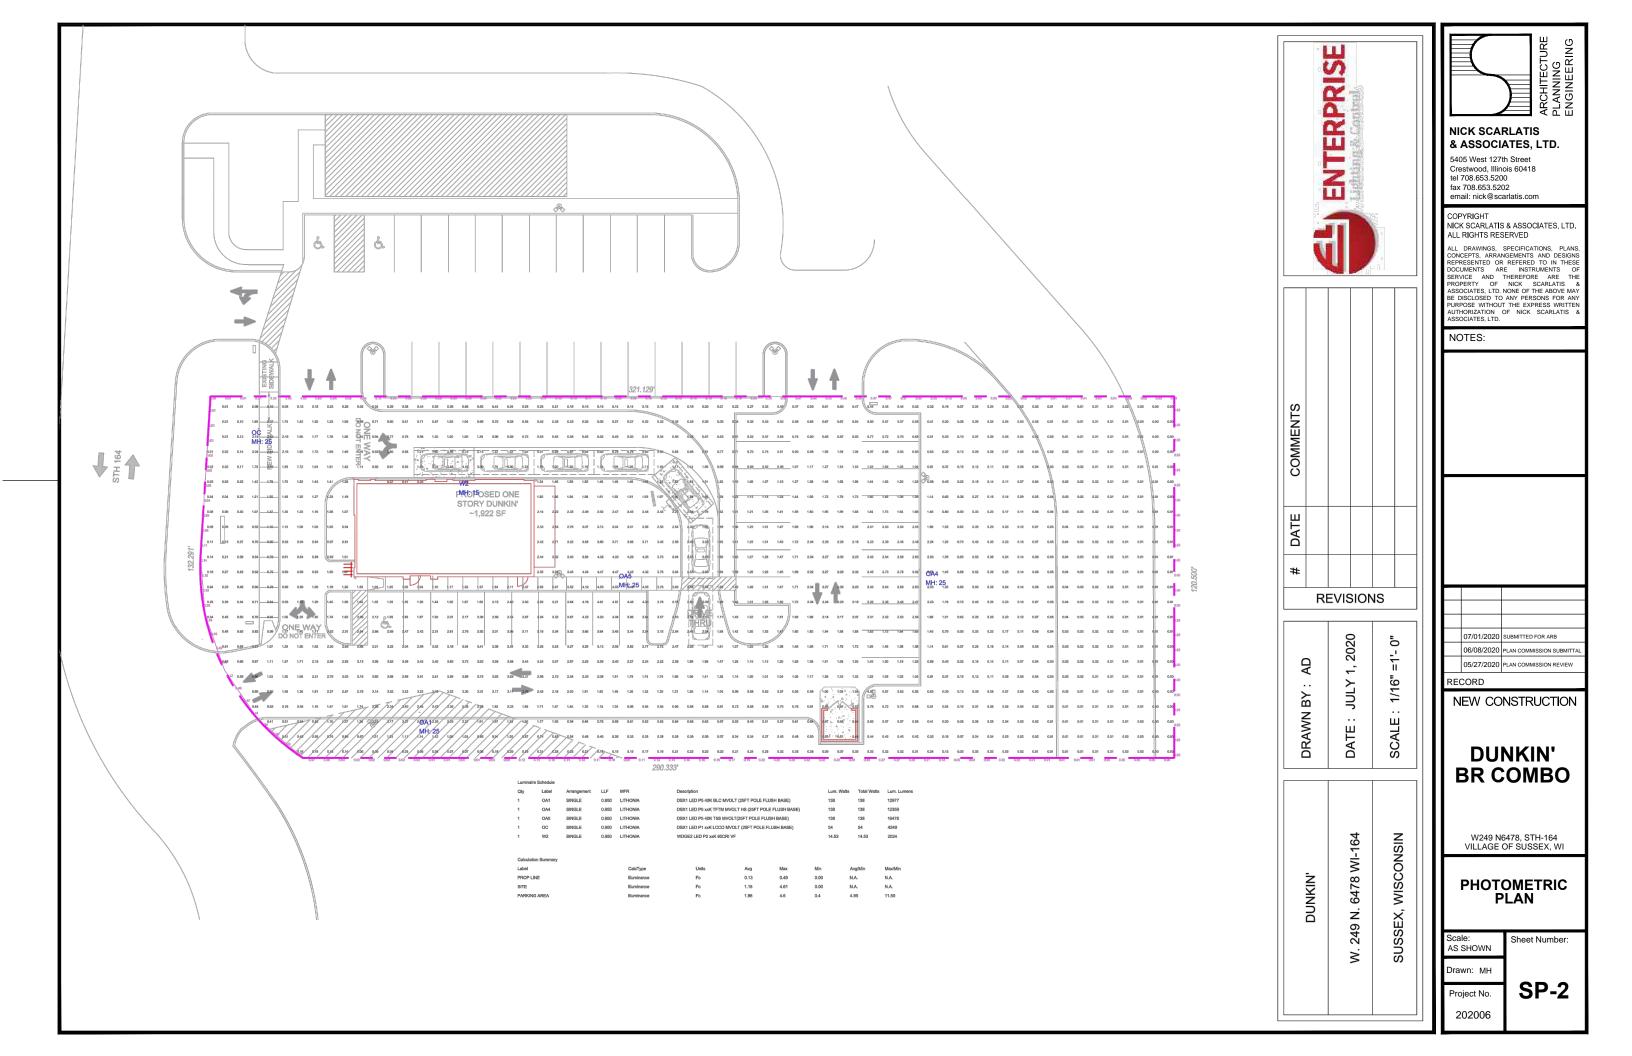

D-Series Size 1


LED Area Luminaire









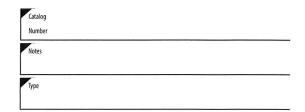

Specifications

EPA: 1.01 ft² (0.09 m²)


Length: 33" (83.8 cm)

Width: 13" (30 cm)

Height H1: 7-1/2"

Height H2: 3-1/2"

Weight 27 lbs (max): (12.2 kg)

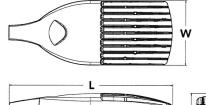



Introduction

The modern styling of the D-Series is striking yet unobtrusive - making a bold, progressive statement even as it blends seamlessly with its environment. The D-Series distills the benefits of the latest in LED technology into a high performance, high efficacy, long-life luminaire.

The outstanding photometric performance results in sites with excellent uniformity, greater pole spacing and lower power density. It is ideal for replacing up to 750W metal halide in pedestrian and area lighting applications with typical energy savings of 65% and expected service life of over 100,000 hours.



Ordering Information

EXAMPLE: DSX1 LED P7 40K T3M MVOLT SPA NLTAIR2 PIRHN DDBXD

DSX1 LED												
Series	LEDs Color temperature			Distrib	Distribution				Mounting			
DSX1 LED	P1 P2 P3	P4 P5 P6 P6 ed optics P12 ¹ P13 ¹	P7 P8 P9	30K 40K 50K	3000 K 4000 K 5000 K	T1S T2S T2M T3S T3M T4M TFTM	Type I short (Automotive) Type II short Type II medium Type III short Type III medium Type IV medium Type IV medium Forward throw medium	T5VS T5S T5M T5W BLC LCCO RCCO	Type V very short ² Type V short ² Type V medium ² Type V wide ² Backlight control ³ Left corner cutoff ³ Right corner cutoff ³	MVOLT 4 120 5 208 5 240 5 277 5 347 5 480 5	Shipped includ SPA RPA WBA SPUMBA RPUMBA Shipped separa KMA8 DDBXD U	Square pole mounting Round pole mounting Wall bracket ² Square pole universal mounting adaptor ⁶ Round pole universal mounting adaptor ⁶ ately

Control option	ontrol options O				options	Finish (required)	
PIRHN PER PER5 PER7 DMG	nLight AIR generation 2 enabled ⁸ Network, high/low motion/ambient sensor ⁹ NEMA twist-lock receptacle only (controls ordered separate) ¹⁰ Five-pin receptacle only (controls ordered separate) ^{10,11} Seven-pin receptacle only (controls ordered separate) ^{10,11} 0-10v dimming wires pulled outside fixture (for use with an external control, ordered separately) ¹³ Dual switching ^{13,14,15}	PIR PIRH PIR1FC3V PIRH1FC3V FAO	High/low, motion/ambient sensor, 8–15' mounting height, ambient sensor enabled at 5fc ^{16,17} High/low, motion/ambient sensor, 15–30' mounting height, ambient sensor enabled at 5fc ^{16,17} High/low, motion/ambient sensor, 8–15' mounting height, ambient sensor enabled at 1fc ^{16,17} Bi-level, motion/ambient sensor, 15–30' mounting height, ambient sensor enabled at 1fc ^{16,17} Field adjustable output ¹⁵	HS SF DF L90 R90	ped installed House-side shield ¹⁸ Single fuse (120, 277, 347V) ⁵ Double fuse (208, 240, 480V) ⁵ Left rotated optics ¹ Right rotated optics ¹ ped separately Bird spikes ¹⁹ External glare shield	DDBXD DBLXD DNAXD DWHXD DDBTXD DBLBXD DNATXD DWHGXD	Dark bronze Black Natural aluminum White Textured dark bronze Textured black Textured natural aluminum Textured white





WDGE2 LED

Architectural Wall Sconce







Catalog Number Notes Type

Specifications


 Depth (D1):
 7"


 Depth (D2):
 1.5"

 Height:
 9"

 Width:
 11.5"

Weight: (without options) 13.5 lbs

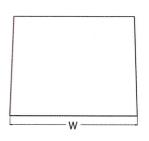

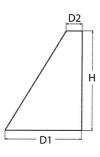

Introduction

The WDGE LED family is designed to meet specifier's every wall-mounted lighting need in a widely accepted shape that blends with any architecture. The clean rectilinear design comes in four sizes with lumen packages ranging from 1,200 to 25,000 lumens, providing a true site-wide solution. Embedded with nLight® AIR wireless controls, the WDGE family provides additional energy savings and code compliance.

WDGE2 delivers up to 6,000 lumens with a soft, non-pixelated light source, creating a visually comfortable environment. When combined with multiple integrated emergency battery backup options, including an 18W cold temperature option, the WDGE2 becomes the ideal wall-mounted lighting solution for pedestrian scale applications in any environment.

WDGE LED Family Overview

Luminaira	Luminaire Standard EM, 0°C	Cold EM, -20°C	Sensor	Lumens (4000K)								
Lummane	Standard EM, U.C.	COIG EW, -20 C	Selizot	P1	P2	P3	P4	P5	P6			
WDGE1 LED	4W			1,200	2,000							
WDGE2 LED	10W	18W	Standalone / nLight	1,200	2,000	3,000	4,500	6,000				
WDGE3 LED	15W	18W	Standalone / nLight	7,500	8,500	10,000	12,000		1			
WDGE4 LED		-	Standalone / nLight	12,000	16,000	18,000	20,000	22,000	25,000			

Ordering Information

EXAMPLE: WDGE2 LED P3 40K 80CRI VF MVOLT SRM DDBXD

Series		Color T	emperature	CRI	Distril	bution	Voltage	Mount	ting			
WDGE2 LED	P1 ¹ P2 ¹ P3 ¹ P4 ¹ P5 ¹	P1SW P2SW P3SW Door with small window (SW) is required to accommodate sensors. See page 2 for more details.	27K 30K 35K 40K 50K ²	2700K 3000K 3500K 4000K 5000K	80CRI 90CRI	VF VW	Visual comfort forward throw Visual comfort wide	MVOLT 347 ³ 480 ³	Shipp SRM ICW	Surface mounting bracket Indirect Canopy/Ceiling Washer bracket (dry/ damp locations only) ⁷	Shippe AWS BBW PBBW	d separately 3/8inch Architectural wall spacer Surface-mounted back box Premium surface-mounted back box (top, left, right conduit entry)

				STANSON NOT THE REAL PROPERTY.	
Options				Finish	
E4WH Emergency battery backup, C E10WH Emergency battery backup, C E20WC Emergency battery backup, C PE4 Photocell, Button Type DS5 Dual switching (comes with see page 3 for details) DMG6 0-10V dimming wires pulled an external control, ordered	EC compliant (10W, 5°C min) EC compliant (18W, -20°C min) PIRH 2 drivers and 2 light engines; outside fixture (for use with exparately) mium back box (PBBW). Total PIRH Netv	IR IRH IR1FC3V IRH1FC3V etworked Ser LTAIR2 PIR	Bi-level (100/3596) motion sensor for 8-15' mounting heights. Intended for use on switched circuits with external dusk to dawn switching. Bi-level (100/3596) motion sensor for 15-30' mounting heights. Intended for use on switched circuits with external dusk to dawn switching. Bi-level (100/3596) motion sensor for 8-15' mounting heights with photocell preprogrammed for dusk to dawn operation. Bi-level (100/3596) motion sensor for 15-30' mounting heights with photocell preprogrammed for dusk to dawn operation. nsors/Controls (only available with P1SW, P2SW & P3SW) nLightAIR Wireless enabled bi-level motion/ambient sensor for 15-30' mounting heights. nLightAIR Wireless enabled bi-level motion/ambient sensor for 15-30' mounting heights.	DDBXD DBLXD DNAXD DWHXD DSSXD DDBTXD DBLBXD DNATXD DWHGXD DSSTXD	Dark bronze Black Natural aluminum White Sandstone Textured dark bronze Textured black Textured natural aluminum Textured white Textured sandstone
		ee page 4 for out of	3 3		




COMMERCIAL OUTDOOR

HAWK - model: WP-LED2

Endurance Wallpack

WAC LIGHTING

Responsible Lighting®

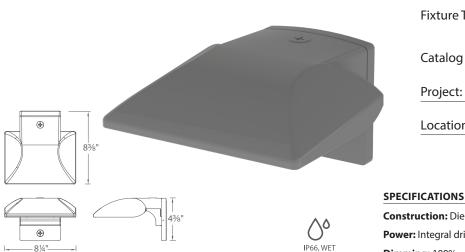

Construction: Die-cast aluminum

Fixture Type:

Project:

Location:

Catalog Number:

Power: Integral driver in luminaire. Universal voltage input (120V-277V)

Dimming: 100% - 30% with 0 - 10V dimmer (120V - 277V)

100% - 15% with Electronic Low Voltage (ELV) dimmer (120V only)

Finish: Architectural Bronze, Graphite, and White Standards: IP66, Wet Location, ETL & cETL Listed

Total Harmonic Distortion: 35%

Operating Temperature: -40°C (-40°F) to 40°C (104°F)


PRODUCT DESCRIPTION

Die cast aluminum factory sealed housings with patent pending design for a water and dust proof IP66 rated outdoor luminaire

FEATURES

- Factory-Sealed LED Light Engine
- Die-Cast Aluminum Construction
- 20° Forward Throw Illumination
- Photo/Motion Sensor Compatible (Sold Separately)
- Built-in Level For Easy Adjustment
- Suitable to install in all directions
- Multi-Function Dimming: ELV (120V) or 0-10V
- 85 CRI
- 100,000 hour rated life

PHOTOMETRY

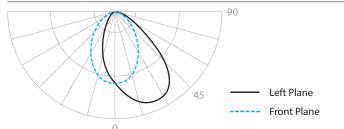

ORDER NUMBER

		Power	Comparable	Color Temp	Delivered Lumens	CBCP	Finish		
	WP-LED219	19W	39W HID	30 3000K 50 5000K	1345 1435	1022 1056	aBZ — aGH	Architectural Bronze Architectural Graphite	
Г	WP-LED227	27W	70W HID	30 3000K 50 5000K	2050 2095	1436 1478	aWT	Architectural White	
				'					

Example: WP-LED219-30-GH


ACCESSORIES







WAC Lighting www.waclighting.com Phone (800) 526.2588 • Fax (800) 526.2585 Headquarters/Eastern Distribution Center 44 Harbor Park Drive • Port Washington, NY 11050 Phone (516) 515.5000 • Fax (516) 515.5050

Western Distribution Center 1750 Archibald Avenue • Ontario, CA 91760 Phone (800) 526.2588 • Fax (800) 526.2585

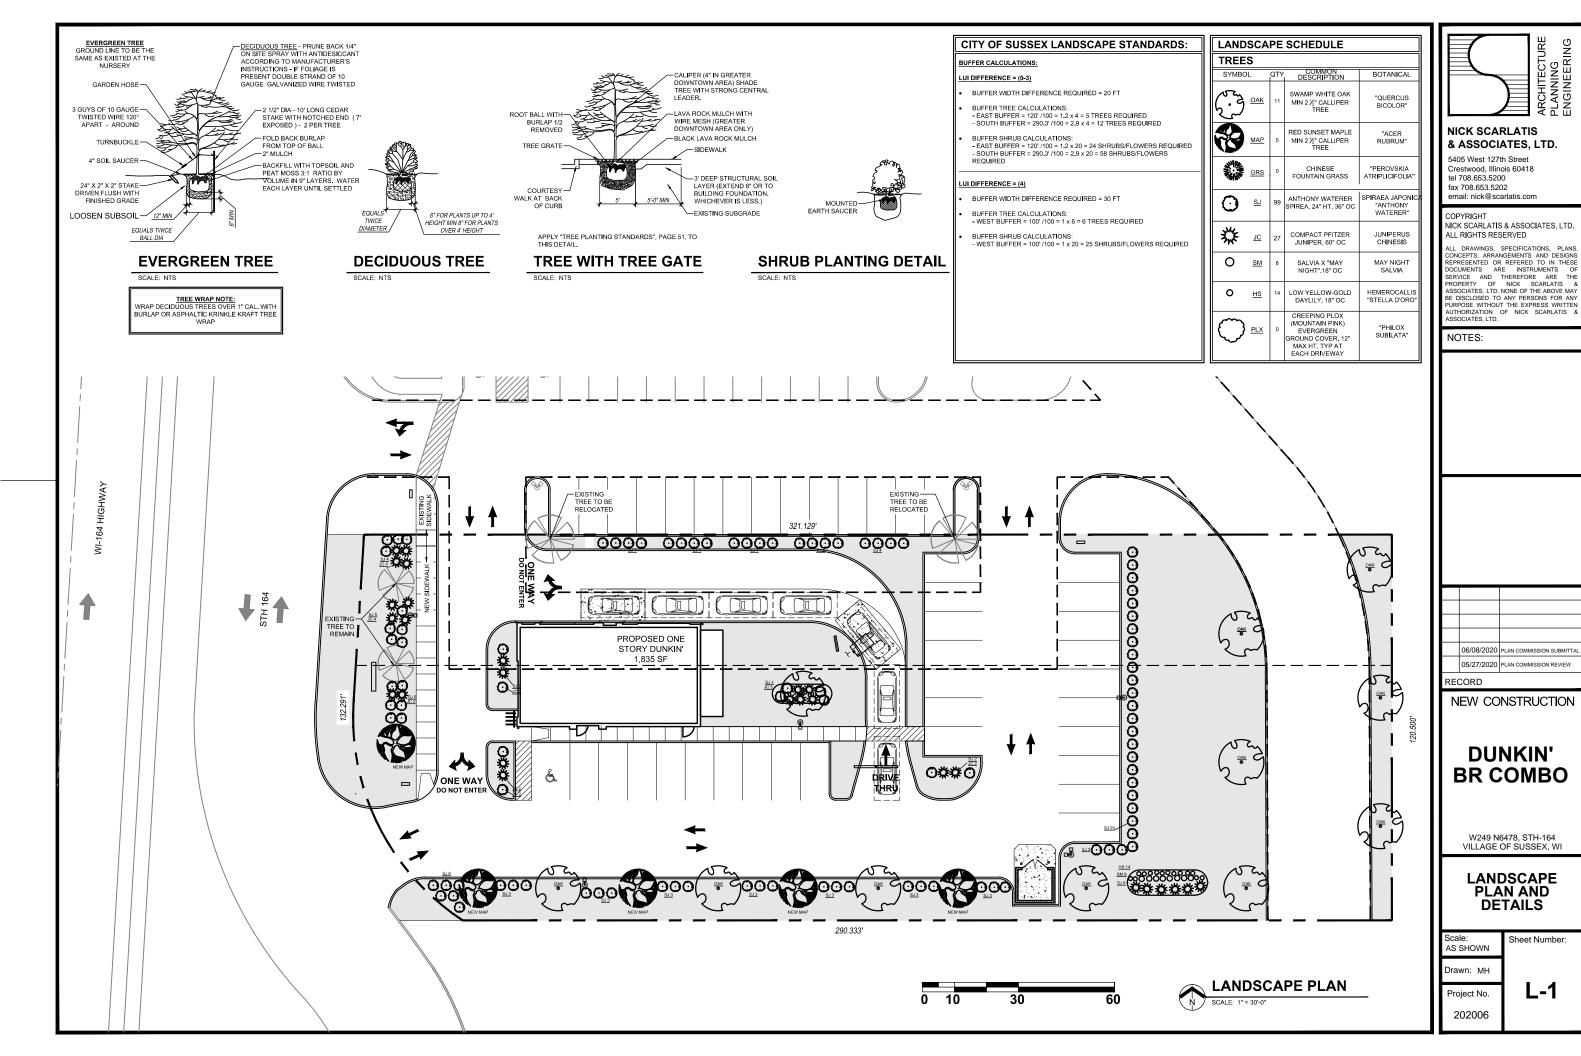

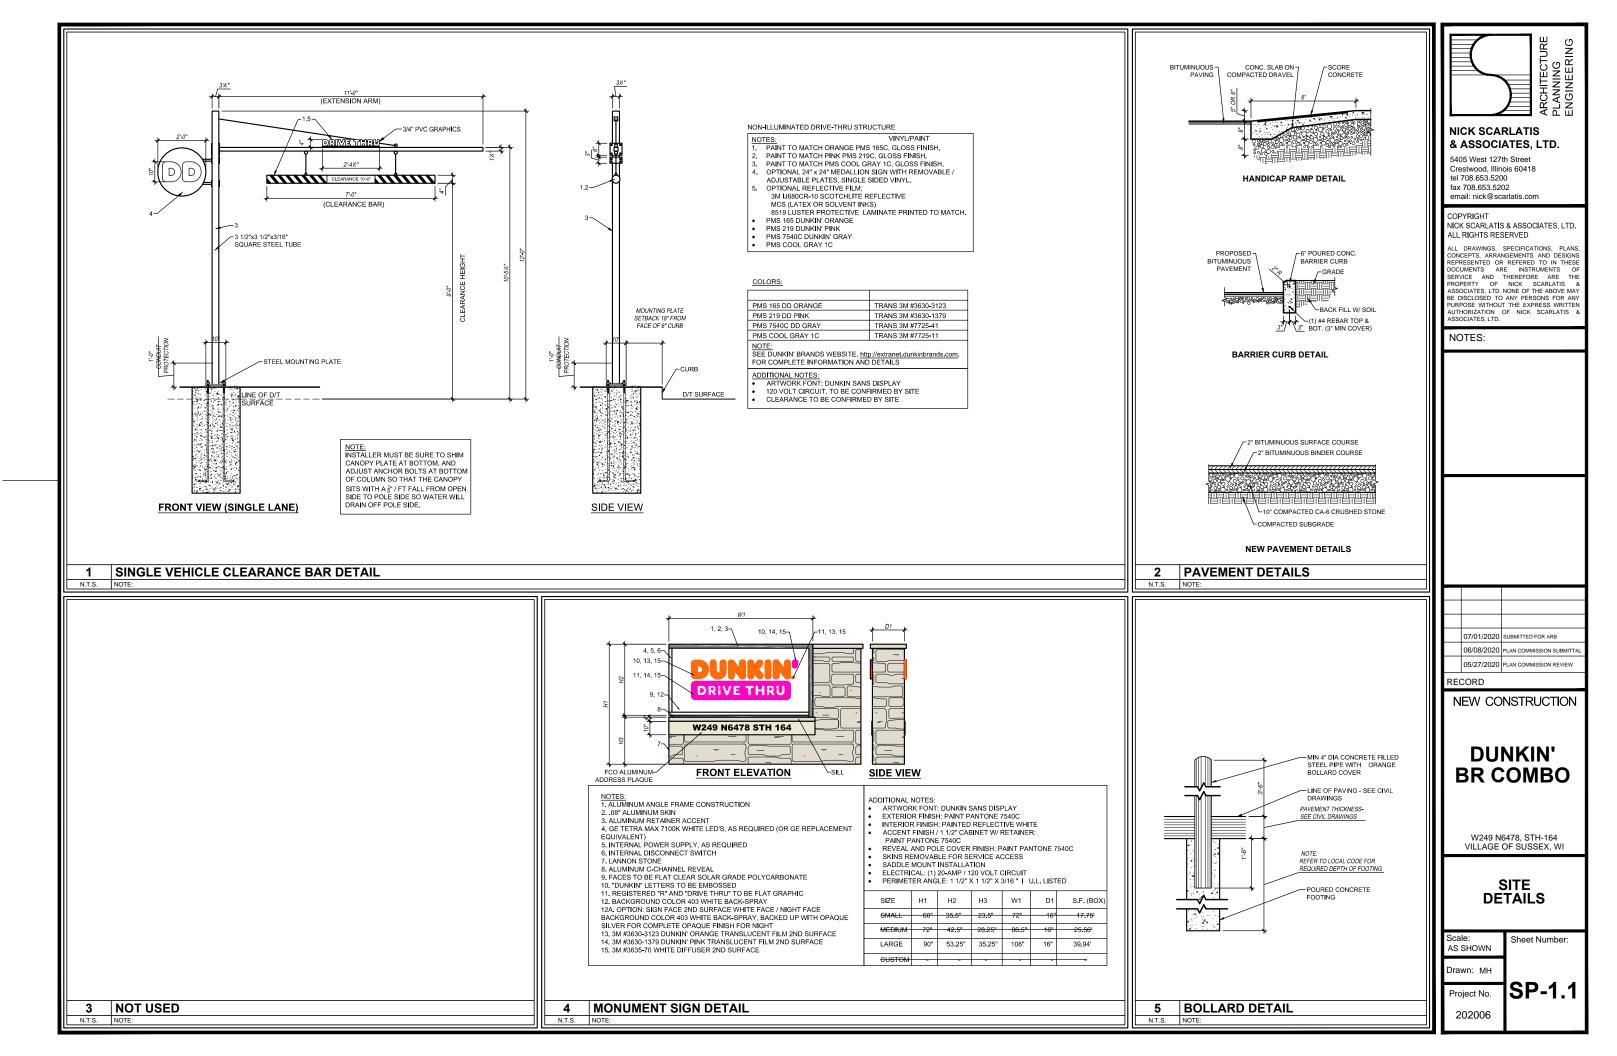

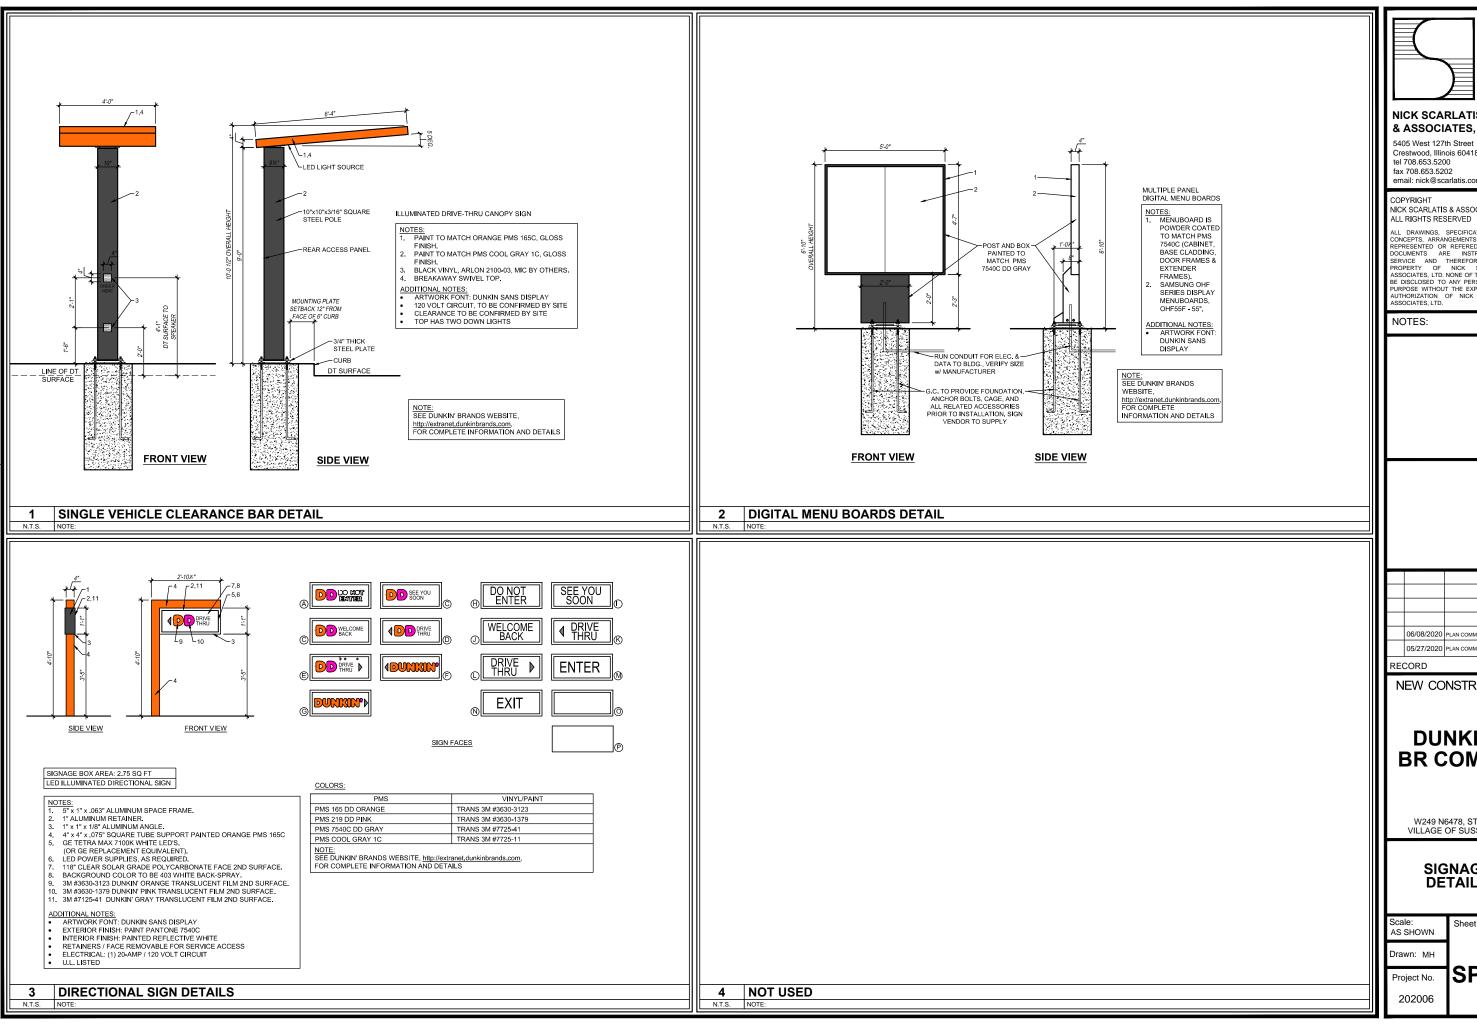

ARCHITECTURE PLANNING ENGINEERING

NICK SCARLATIS & ASSOCIATES, LTD.

Crestwood, Illinois 60418 tel 708.653.5200 fax 708.653.5202 email: nick@scarlatis.com

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06/08/2020 PLAN COMMISSION SUBMITT 05/27/2020 PLAN COMMISSION REVIEW

NEW CONSTRUCTION


DUNKIN' BR COMBO


W249 N6478, STH-164 VILLAGE OF SUSSEX, WI

SIGNAGE DETAILS

Sheet Number:

SP-1.2

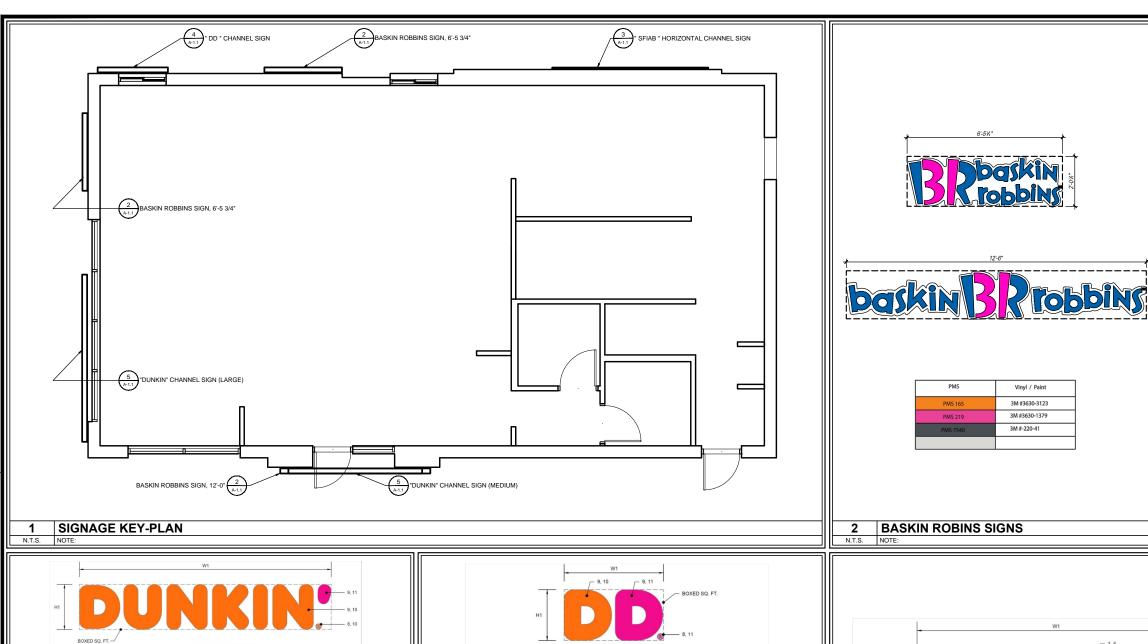

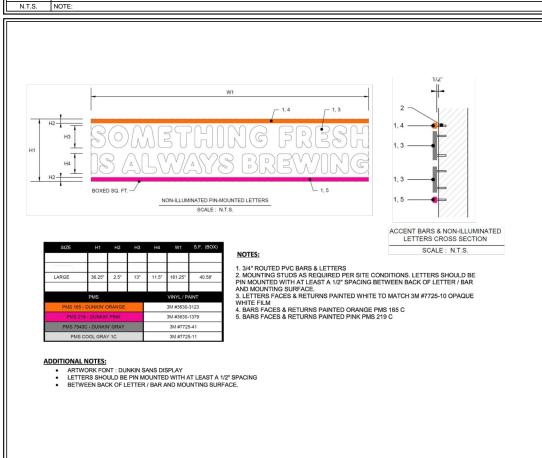



Crestwood, Illinois 60418 tel 708.653.5200 fax 708.653.5202 email: nick@scarlatis.com

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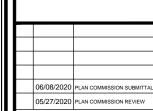
LL DRAWINGS, SPECIFICATIONS, PLANS ALL DRAWINGS, SPECIFICATIONS, PLANS, CONCEPTS, ARRANGEMENTS AND DESIGNS REPRESENTED OR REFERED TO IN THESE DOCUMENTS ARE INSTRUMENTS OF SERVICE AND THEREFORE ARE THE PROPERTY OF NICK SCARLATIS & ASSOCIATES, LTD. NONE OF THE ABOVE MAY DEL DISCLOSED TO ANY PERSONS FOR ANY PURPOSE WITHOUT THE EXPRESS WRITTEN AUTHORIZATION OF MICK SCARLATIS & ASSOCIATES, LTD.

NOTES:

Optix #2406 White

Plexi Faces with Flooded Trans Grap

Stock Pre-Finished Stock Pre-Finished Aluminum Returns



RECORD

NEW CONSTRUCTION

DUNKIN' BR COMBO

W249 N6478, STH-164 VILLAGE OF SUSSEX, WI

BUILDING SIGNAGE


Sheet Number: AS SHOWN

Drawn: MH Project No.

202006

A-1.1

3 "SFIAB "HORIZONTAL CHANNEL SIGN

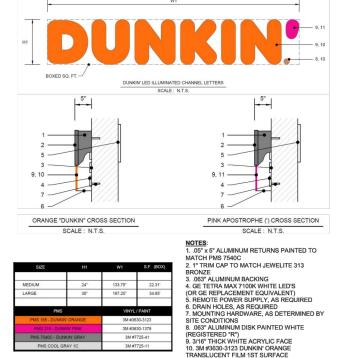


TRANSLUCENT FILM 1ST SURFACE
11. 3M #3630-1379 DUNKIN' PINK TRANSLUCENT

FILM 1ST SURFACE

ADDITIONAL NOTES:

ARTWORK FONT: DUNKIN SANS DISPLAY
CHANNEL LETTER INTERIOR PAINTED REFLECTIVE WHITE
ELECTRICAL: (1) 20-AMP / 120 VOLT CIRCUIT
UL. LISTED
LED'S TO BE POPULATED FOR EVEN AND CONSISTENT LIGHTING WITHOUT HOT SPOTS OR SHADOWS

5 "DUNKIN" CHANNEL SIGN

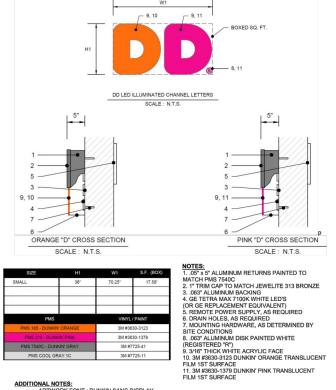

3M #7725-41


4 " DD " CHANNEL SIGN

N.T.S. NOTE:

FILM 1ST SURFACE

ARTWORK FONT: DUNKIN SANS DISPLAY
CHANNEL LETTER INTERIOR PAINTED REFLECTIVE WHITE
ELECTRICAL: (1) 20-AMP / 120 VOLT CIRCUIT
U.L. LISTED
LED'S TO BE POPULATED FOR EVEN AND CONSISTENT LIGHTING WITHOUT HOT SPOTS OR SHADOWS



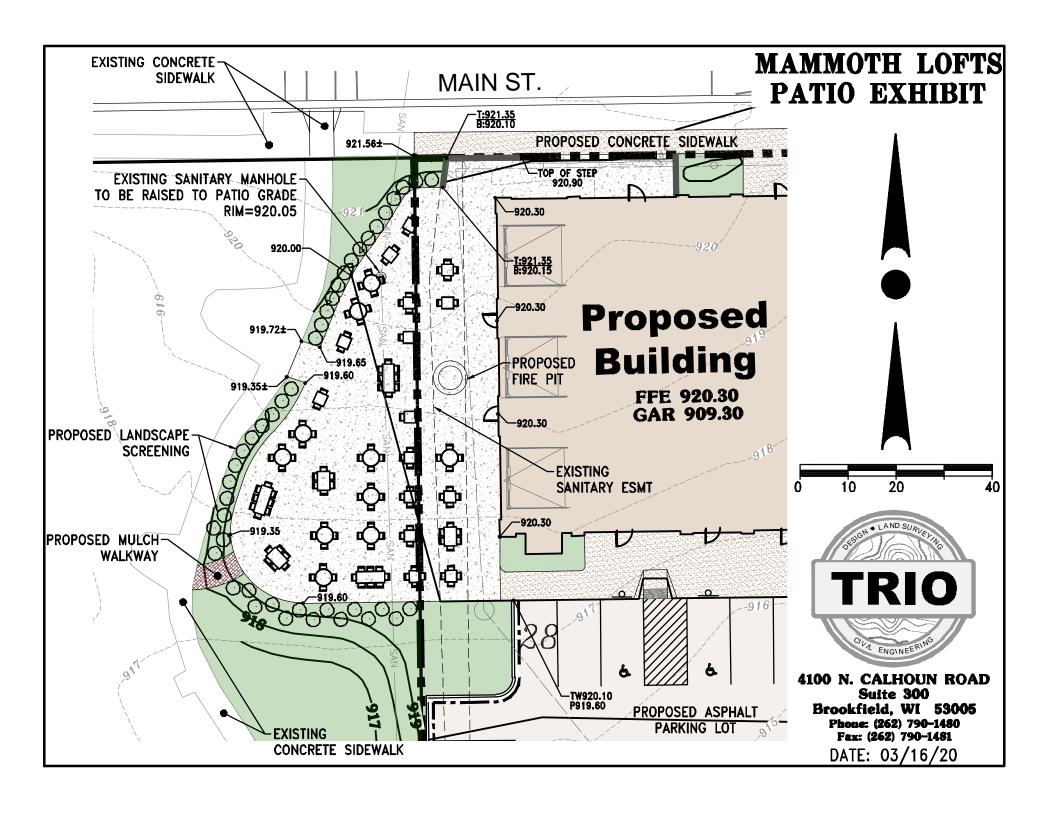



Village of Sussex - Master Sign Program

Project Name: Mammoth Springs at The Corners

Property Address: Main Street & Silver Spring Drive, Sussex, WI 53089

Current Zoning: B-4 Central Mixed-Use Business

Applicant Name: Sawall Development

Contact: Arthur Sawall – <u>arthur@sawalldevelopment.com</u>

Applicant Address: N63 W23217 Main St #200

City: Sussex State: WI Zip: 53089

Intent

This document comprises the Master Sign Program (MSP) for Mammoth Springs at The Corners (previously known as Mammoth Lofts) located on the corner of Main Street and Silver Spring Drive in the Village of Sussex. Mammoth Springs at The Corners is a mixed-use business development consisting of retail space and luxury multifamily housing. The intent of the MSP is to set forth a theme as to placement, lettering style, color, materials, mounting method and other related design considerations of signs, while at the same time reducing sign clutter.

Approval Procedure

Separate Sign Permits are required for each individual sign throughout the development and will be issued by the Village of Sussex Department of Building Inspection. Prior to application, the tenant shall obtain initial approval from the Owner of Mammoth Springs at The Corners and the application must bear the signature and/or stamp of the appropriate Owner representative(s).

Professionally Prepared

All signs and sign plans shall be "professionally" prepared and demonstrate dimensions, letter style and type, materials, color selection, and craftsmanship. Applications to the Village of Sussex Department of Building Inspection for sign permits shall include professionally rendered imagery and dimension scale drawings and shall depict the type of light source, all materials, and colors.

Mammoth Springs at The Corners Master Sign Plan

Interior Signage

Permanent window signs will be allowed and may-not-exceed twenty five percent (25%) of the gross window area in which they are installed.

All national accounts such as Subway, Quiznos, etc. would be allowed to use their corporate colors for their signage. All signs must be approved by the Landlord as well as the Village of Sussex prior to permit being issued by the Village of Sussex.

Wall Signage

1. Theme, Color, Size & Style:

Tenant Wall Sign – Maximum height 24" acrylic letters attached to a common extruded aluminum raceway. Minimum height is 20". Only a single line of text is allowed. The height of our building facade is too short to allow for stacked lines of text. Text per sign is allowed in a single color only. A single color logo or graphic may be allowed within the wall sign allowance. This theme meets a variety of tenants' needs while still providing elegant continuity for the Village's Main Street.

Signs will be illuminated from within also known as "face-illuminated" as opposed to external lighting such as a gooseneck lamp shining onto the sign to illuminate it. Some renderings may appear to have a backer panel to which signs are commonly mounted to, however in the renderings for this development, this space is simply illustrating the area and square footage to which the signs are constrained to.

Letter style may match corporate identification for all tenants (block, script, serif, etc.). Corporate logos may be used in conjunction with letters when such logos are part of a corporate identity. The maximum vertical logo height shall be limited to the maximum letter height allowed. All signs will have steady illumination. No flashing or blinking lights will be permitted.

2. Proposed Location:

Tenant Wall – Wall signs shall use the designated sign band. Tenants with multiple entrances will only be allowed one wall sign per side of the building. Upon approval of landlord and as allowed by the Village of Sussex Sign Code Section 17.0807 J, end cap tenants may be allowed an additional wall sign to maximize visibility to

customers. Sign text and logos shall be placed within the applicable allowable sign zone consistent with the following guidelines.


- 1. With each wall sign placed within a designated sign band, the vertical orientation of the wall sign must be within the allowable sign zone and be evenly balanced relative to a horizontal line running through the horizontal center of the allowable sign zone.
- 2. Each wall sign shall be placed and sized in a manner such that it does not interfere with any architectural elements of the building.

3. Proposed Size:

Tenant Wall – The maximum square footage allowed for exterior wall signs will be determined based on the size of the sign band and the quantity of tenant wall signs in that space. Current sizes are uniform to ensure a clean and professional design.


The following chart shows the square footage allowed for single wall signs in the designated sign band.

Sign Band	Max Height	Max Length	Max SF
9 Center Bands on both North & South Sides	24"	144"	24
2 End Bands on both North & South Sides (Corner Units)	24"	300"	50
Both East & West Band (Corner Units' Additional)	24"	300"	50

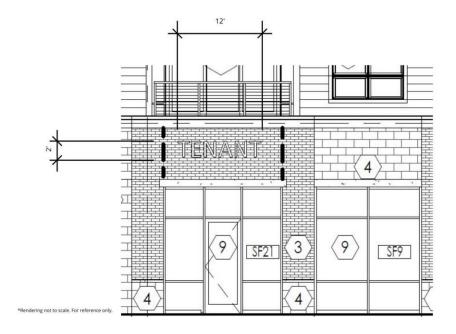


Building Layout

Both North and South sides of the building have 9 possible sign locations at maximum dimensions 2' in height and 12' in length. Additionally, the corner units on both the North and South sides have the longer sign locations at maximum dimensions 2' in height and 25' in length.

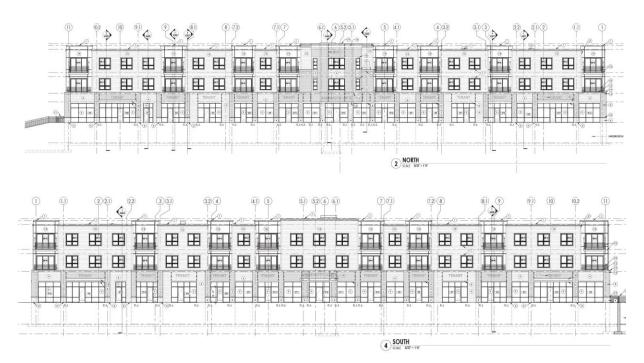


The East and West sides of the building each have one more location for the longer sign maximum dimensions of 2' in height and 25' in length. Signage may not exceed 25' in length on the East and West sides because the center third of the building's design is a bump out.

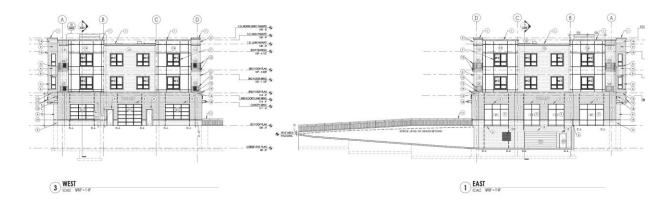

Face-Illuminated Sign Design

Below is a drawing prepared by South Water Signs for Mammoth Springs at The Corners' illustrating the face-illuminated raceway mounted sign. All rights reserved. Each retail sign at Mammoth Springs at The Corners must be installed with the design concept of face-illuminated raceway mounted signs.

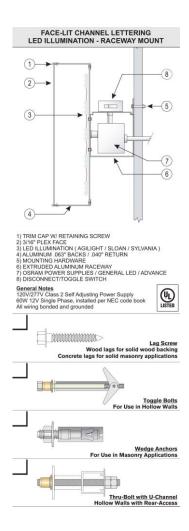

All signage must be approved by the Landlord as well as the Village of Sussex prior to permit being issued by the Village of Sussex.

For questions and clarifications, please contact Sawall Development at (262) 297-4444. N63 W23217 Main St #200, Sussex, WI 53089.