

N64W23760 Main Street Sussex, Wisconsin 53089 Phone (262) 246-5200 FAX (262) 246-5222

Email: <a href="mailto:info@villagesussex.org">info@villagesussex.org</a>
Website: <a href="mailto:www.villagesussex.org">www.villagesussex.org</a>

## Architectural Review Board Agenda 4:00 PM Wednesday, JUNE 5, 2024 Sussex Civic Center – Committee Room Second Floor

Pursuant to the requirements of Section 19.84, Wis. Stats., notice is hereby given of a meeting of the Village of Sussex Architectural Review Board, at which a quorum of the Village Board may attend in order to gather information about a subject which they have decision making responsibility. The meeting will be held at the above noted date, time and location. (If a Quorum is present the Chairperson shall announce, "Please let the minutes reflect that a quorum of the Village Board is present and that the Village Board members may be making comments under the Public Comments section of the agenda, during any Public Hearing(s) or if the rules are suspended to allow them to do so.)

- 1. Roll call.
- 2. <u>Consideration and possible action on the minutes of April 3, 2024.</u>
- 3. <u>Discussion and possible action on site plan, landscape plan, architecture plan, and lighting plan for Highlands Business Park Site XII.</u>
- 4. <u>Consideration and possible action on the site plan, architectural plan, lighting plan, landscape plan for Club Carwash located at W248N5221 Executive Dr in the B-3 Highway Business Zoning District.</u>
- 5. Adjournment.

Anthony LeDonne	
Chairperson	
enumperson	
T C '.1	
Jeremy Smith	

Please note that, upon reasonable notice, efforts will be made to accommodate the needs of disabled individuals through appropriate aids and services. For additional information or to request this service, contact Jeremy Smith at 246-5200.



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#### **MEMORANDUM**

TO: Architectural Review Board

FROM: Gabriel Gilbertson, Community Development Director

RE: June 5, 2024 Architectural Review Board

DATE: Friday, May 31, 2024

The following is background information for the ARB agenda items (Design Standards 3-25-2014)

### I. Roll call.

II. Consideration and possible action on the ARB minutes of April 3, 2024.

## III. <u>Discussion and possible action on site plan, landscape plan, architecture plan, and lighting</u> plan for Highlands Business Park Site XII.

The site is zoned BP-1 Business Park with a PDO. An industrial building is a permitted use under 17.0420(6). The 139,111 square foot speculative building can accommodate multiple tenants, which will need to receive individual plan of operation approvals at such time as they wish to occupy the building.

The Plan Commission reviewed the site plan and use ad its May 18, 2024 meeting and approved the submitted plans.

#### Site

- Green space requirement is met at 38.2%.
- Entry points have been consolidated and provided separate for cars from trucks –
  ultimately the truck entrance will also provide vehicular access for the future
  industrial building located to the north.
- Site to have 90 parking stalls parking requirements to be determined when individual Plan of Operations are submitted for tenants.

#### Architecture

- Building meets height and required setbacks.
- Location of any RTU's are not known at this time. When their locations are known, a plan shall be submitted to staff that includes the type of screening that will be used.
- Material to be used meets the Design Standards.
- Windows are included on each elevation. Percentage of window and door openings needed for the front (south) elevation. The applicant stated that additional glazing has been added to the achieve the minimum 20% required for window and door openings, but a note should be made on the plans that includes that information.

• The proposed dumpster enclosure is chain-link fence and needs to be constructed of similar materials or architecturally match the principal building. Revised elevations of the enclosure is needed.

## Lighting

• Lighting appears to meet the standards. If the light poles are to be mounted on bases, the bases are factored into the overall height of the fixture and need to be painted to match the building.

#### Landscape

• The site has 119 trees, when 64 are required. The site has 250 shrubs, when 320 are required. The plan meets the requirements of the design guidelines for trees, but additional shrubs are required.

#### Sign

• Base and pillar materials meets the requirements of the design guidelines. A sign permit will be required prior to any installation of a sign and be reviewed by Staff.

## **Policy Question:**

1. Are there any concerns with the proposed site plan, landscape plan, architecture plan, and lighting plan?

#### **Action Items:**

1. Act on the submitted plans.

**Staff Recommendation:** Staff recommends the Architectural Review Board approve site plan, landscape plan, architecture plan, and lighting plan for Highlands Business Park Site XII, subject to the following conditions:

- 1. Submit revised plans for the dumpster enclosure that meet the requirements of the design guidelines to Staff for review.
- 2. Submit revised landscape plan that meets the minimum shrub requirements to Staff for review.
- 3. Submit details on how the proposed light poles will be installed for Staff to review.
- 4. Include a note on the elevations that with the percentage of window/door openings for each elevation to Staff for review.

## IV. Consideration and possible action on the site plan, architectural plan, lighting plan, landscape plan for Club Carwash located at W248N5221 Executive Dr in the B-3 Highway Business Zoning District.

The subject property is zoned B-3 Highway Business and is located in the Sussex Gateway Retail Center development on the northeast corner of State Highway 164 and Lisbon Road. The land is currently vacant and the applicant is proposing to construct a Club Carwash. Section 17.0506(9)(A)(1) requires a Conditional Use Permit for vehicle washing in the B-3 Highway Business District.

The proposed carwash is going through the Conditional Use Permit process at the Plan Commission.

#### Site

• Greenspace requirement is met at 51.1%.

• Site meets minimum requirements for parking stalls.

#### **Architecture**

- Building meets height and required setbacks.
- Material to be used meets the Design Standards smooth face CMU block with architectural elements and details.
- Windows are included on each elevation the south elevations appears to meet the minimum requirements of the design guidelines for windows on the road facing façade, but the applicant will need to provide details to confirm.

#### Lighting

• The lighting plan is proposing 20' poles on 2'6" bases. The bases should be buried, however, if they are to be exposed, they will need to painted to match the building. The lighting plan should be revised to reflect how this will be addressed.

#### Landscape

• The Sussex Design Guidelines require a total of 36 trees and 184 shrubs. The submitted landscape plan has 36 trees and 185 shrubs. The landscape plan meets the minimum requirements of the design guidelines.

#### Sign

• Any proposed wall signs or monument signs will require sign permits and be reviewed by Staff for compliance with the design guidelines.

#### **Policy Question:**

1. Are there any concerns with the various plans?

#### **Action Items:**

1. Act on the various plans.

<u>Staff Recommendation:</u> Staff recommends the Architectural Review Board approve the site, architectural, and landscape plan for Club Carwash located at W248N5221 Executive Dr in the B-3 Highway Business Zoning District, subject to the following conditions:

- 1. Submitting revised elevations with the percentage of window/door openings on the south elevation to Staff for review.
- 2. Submitting a revised lighting plan that addresses how the bases of the light poles will be handled to Staff for review.

## VILLAGE OF SUSSEX SUSSEX, WISCONSIN

Minutes of the Architectural Review Board (ARB) meeting held on April 3, 2024.

President LeDonne called the meeting to order at 4:03 p.m.

Members present: Anthony LeDonne, Gary Foxe, Stacy Reidel, and Michael Smith

Members absent: Mike Knapp

Others present: Gabe Gilbertson, Community Development Director

#### Consideration and possible action on the minutes of February 7, 2024.

A motion Smith, seconded by Foxe to approve the minutes of the meeting held on February 7, 2024.

All ayes, motion carried.

## Consideration and possible action on exterior window vinyl for The Dollar Tree located at W249N5245 Executive Dr.

A motion by President LeDonne, second by Foxe to approve the proposed installation of a green vinyl on the windows of the Dollar Tree tenant space.

All ayes, motion carried.

## Consideration and possible action on the site plan, architectural plan, lighting plan, landscape plan for a Mr. D's Carwash.

Member Stacy Reidel arrived at 4:19 p.m.

Motion by President LeDonne, second by Reidel to approve the site, architectural, and landscape plan for Mr. D's Carwash located at the parcel identified by Tax Key No. 231.997.014, subject to the following conditions:

- 1. Submitting a revised site plan to Staff that includes additional evergreen trees on the northern corner of the subject property to provide additional screening from the residential multi-family buildings to the north.
- 2. Submitting revised elevations to Staff that provide the required amount of window and door openings on the street yard elevation facing State Highway 164.
- 3. Submitting a lighting plan to Staff that meets the requirements of the Sussex Design Standards.

All ayes, motion carried.

A motion by Foxe, seconded by Reidel to adjourn the meeting at 4:39 pm.

All ayes, motion carried.

Respectfully submitted, Jeremy Smith, Village Administrator

## PROJECT:

# WANGARD HIGHLANDS - SITE XII

SUSSEX, WISCONSIN



ISSUED FOR: MUNICIPAL REVIEW COMMENTS

ARCHITECT:

STEPHEN PERRY SMITH ARCHITECTS, INC.

MILWAUKEE, WISCONSIN



215 N. WATER STREET, SUITE 250 MILWAUKEE, WI 53202 T 414.277.9700 | F 414.277.9705 spsarchitects.com





PROPOSED BUILDING FOR:



WANGARD HIGHLANDS - SITE XII

SUSSEX, WISCONSIN

OWNER




**REVISIONS** 

INFORMATION

PROJECT ARCHITECT PROJECT MANAGER <u>ISSUED FORMUNICIPAL REVIEW COMMENTS</u>



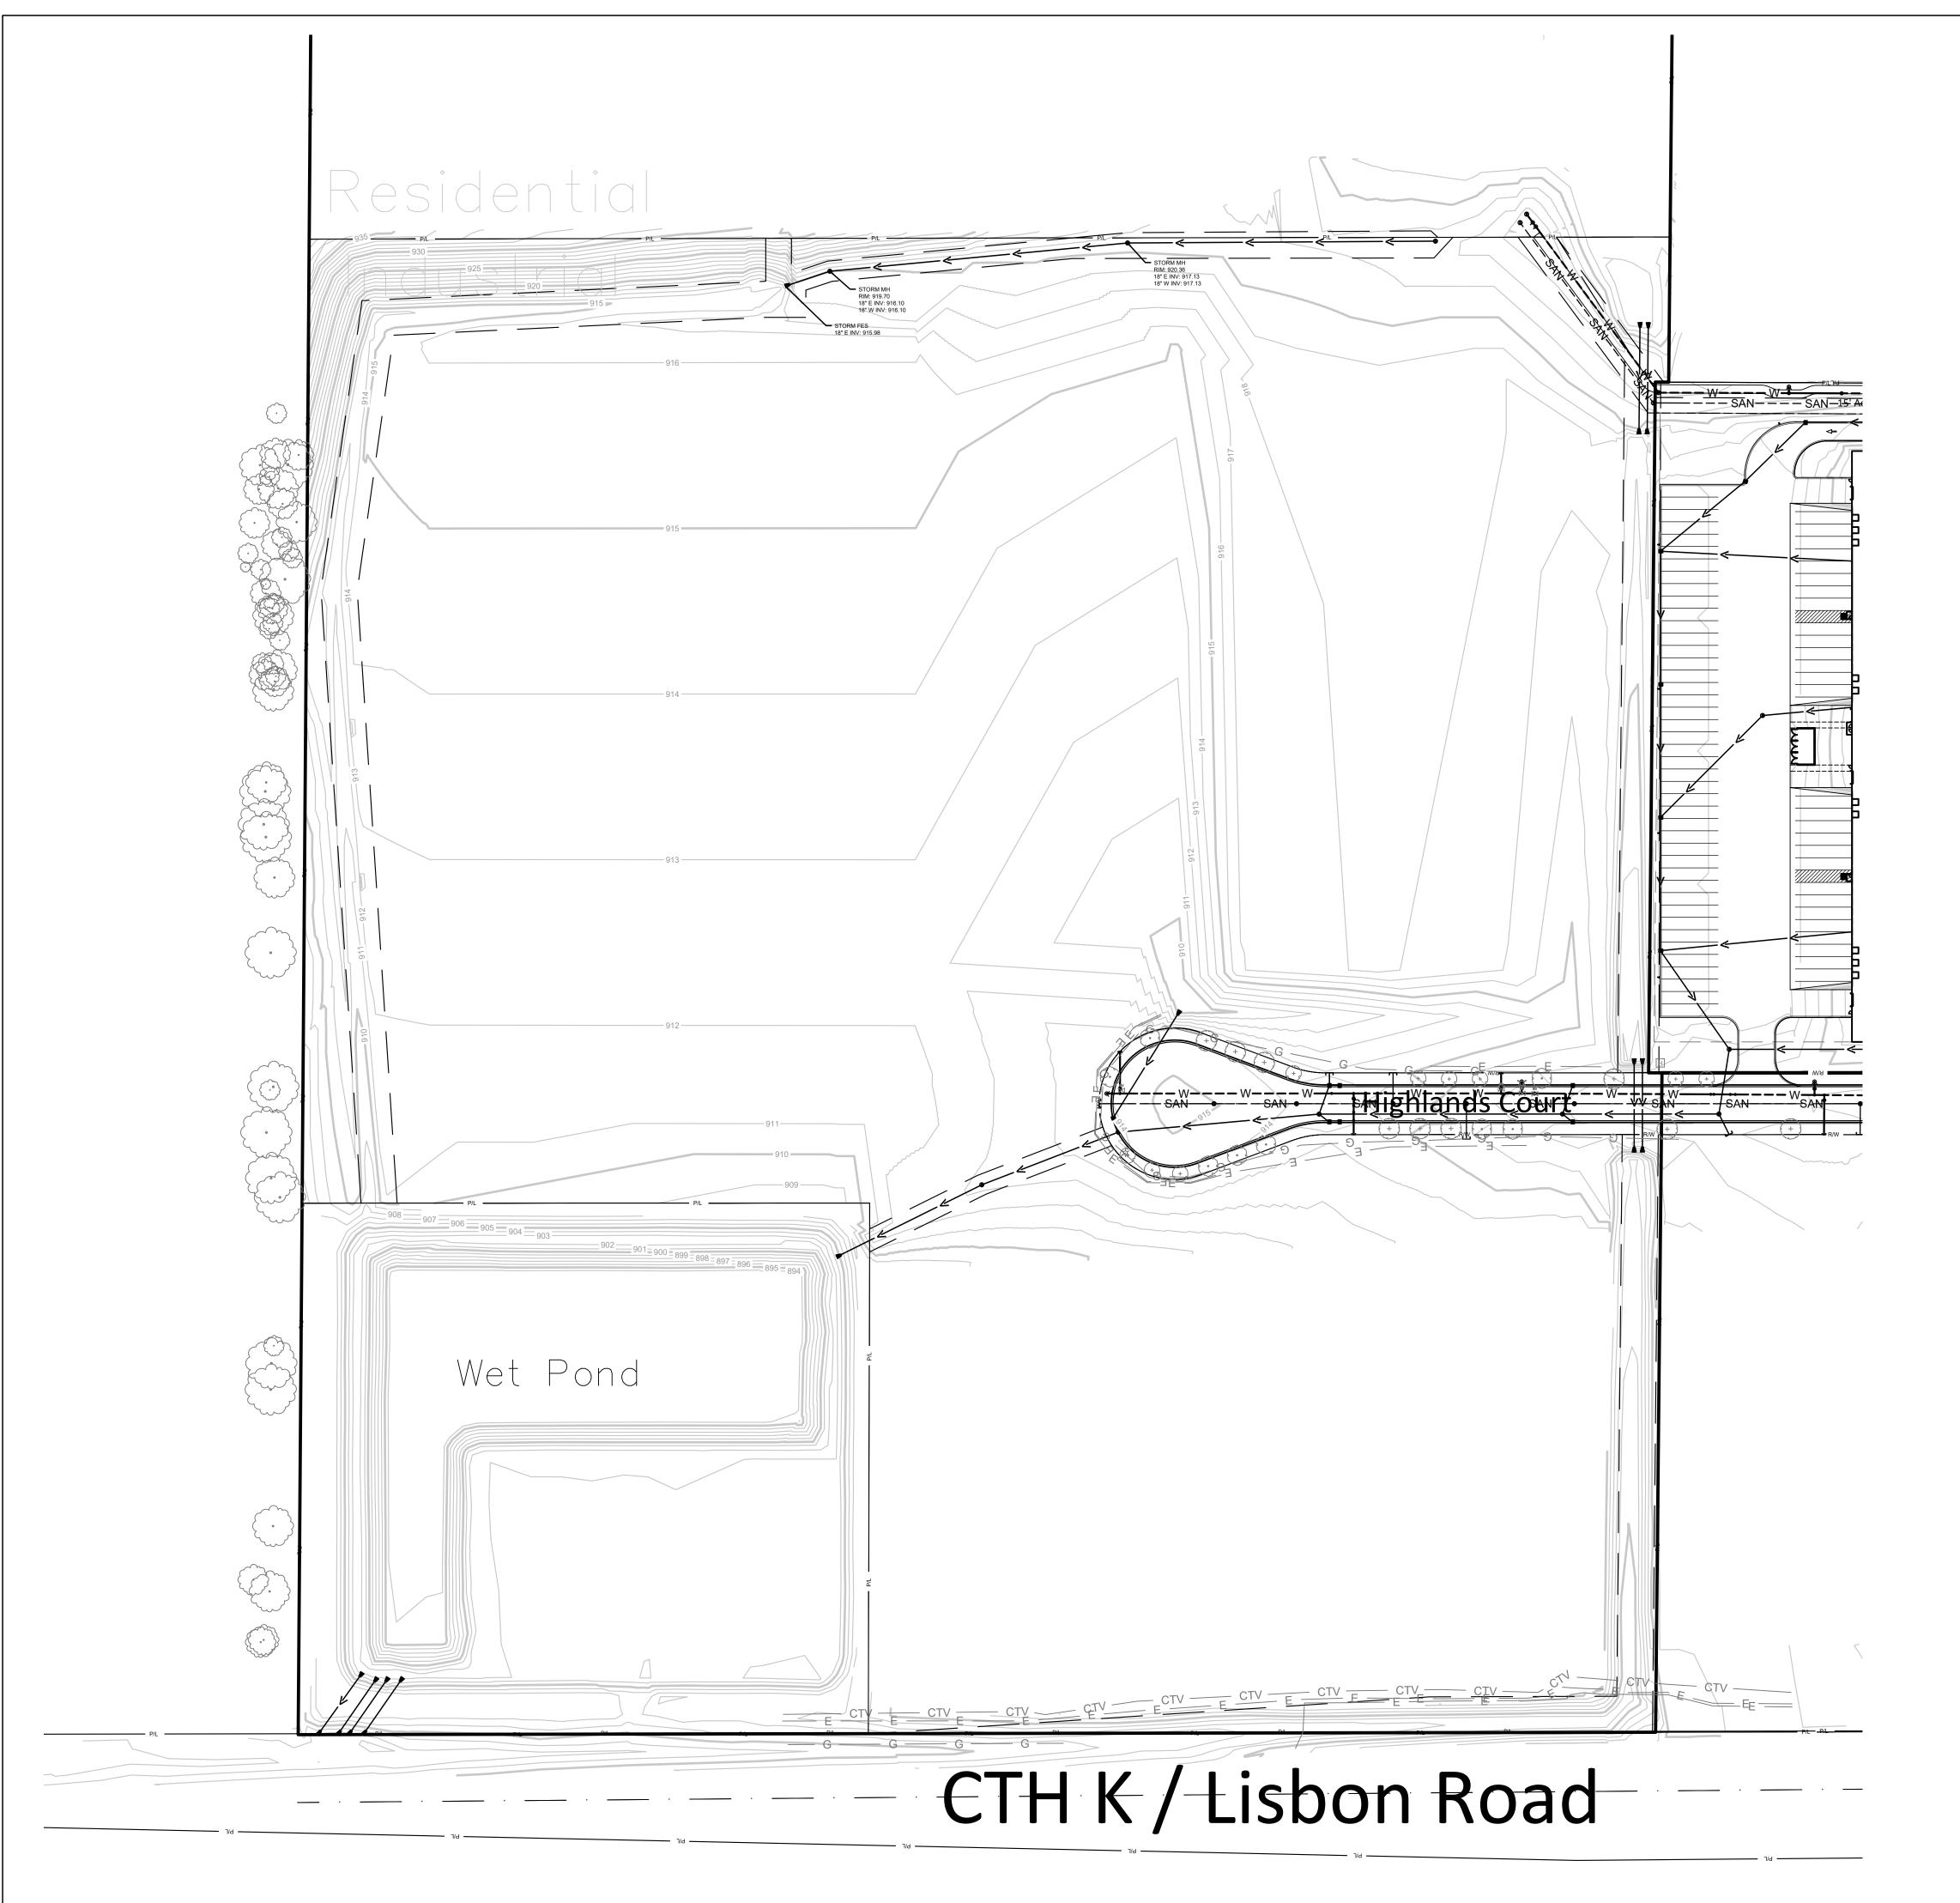



SECTION 1/4 SECTION LINE PROPERTY LINE EASEMENT CHAIN LINK FENCE **GUARD RAIL** METAL FENCE \_\_\_\_ WOOD FENCE TREE LINE —— OH —— OVERHEAD UTILITY LINE ELECTRIC TELEPHONE FIBER OPTIC CABLE TV SANITARY SEWER FORCE MAIN STORM SEWER WATER MAIN GAS **EXISTING CONTOUR** \_\_\_\_ WET \_\_\_\_ WETLAND ——FP——— FLOODPLAIN

**WH** UNKNOWN MANHOLE

IRON PIPE FOUND/SET REBAR FOUND/SET S SANITARY MANHOLE ® STORM MANHOLE **⊙**PK PK NAIL FOUND/SET

SPIKE/NAIL

■ MONUMENT

─o SIGN

∰ BUSH

POST

BENCHMARK

SOIL BORING

LIGHT POLE

Ø UTILITY POLE

─ GUY WIRE

GUY POLE

TRAFFIC SIGNAL

DARKING METER

( )8" DECIDUOUS TREE

\*CONIFEROUS TREE

E ELECTRIC MANHOLE MSD MANHOLE ① TELEPHONE MANHOLE

CATCH BASIN CATCH BASIN (ROUND)

ROOF DRAIN ) CULVERT END HYDRANT

WATER VALVE ₩ GAS VALVE G GAS METER

**E** ELECTRIC METER P UTILITY PEDESTAL 

MONITORING WELL

## **GENERAL NOTES:**

1. THE UNDERGROUND UTILITY INFORMATION SHOWN ON THIS DRAWING IS BASED ON FIELD LOCATIONS AND/OR RECORDS FURNISHED BY MUNICIPALITIES AND UTILITY COMPANIES. THE LOCATION AND ACCURACY OF WHICH CANNOT BE GUARANTEED. THERE MAY BE ADDITIONAL UNDERGROUND UTILITY INSTALLATIONS WITHIN THE PROJECT AREA THAT ARE NOT SHOWN.

2. VERIFY ACTUAL LOCATIONS AND INVERTS IN THE FIELD. ANY POTENTIAL ERRORS, OMISSIONS, OR DISCREPANCIES SHALL BE BROUGHT TO THE ATTENTION OF THE ENGINEER PRIOR TO PROCEEDING WITH CONSTRUCTION.

3. DRAWING IS BASED ON DESIGN FILES PREPARED BY SIGMA DATED OCTOBER 2022 AND ON FIELD SURVEY COMPLETED BY THE SIGMA GROUP ON NOV 2020.


4. DATUM FOR THE PROJECT SURVEY IS USGS NGVD29. BENCHMARK FOR THE PROJECT SURVEY IS NE 1/4 OF SEC 33-8-19. ELEV. = 946.10.

5. CONTRACTOR TO VERIFY EXISTING CONDITIONS, CONTACT ENGINEER WITH DISCREPANCIES.

THE UNDERGROUND UTILITY INFORMATION SHOWN ON THIS MAP IS BASED ON FIELD MARKINGS AND INFORMATION FURNISHED BY UTILITY COMPANIES AND THE LOCAL MUNICIPALITY. WHILE THIS INFORMATION IS BELIEVED TO BE RELIABLE, ITS ACCURACY AND COMPLETENESS CANNOT BE GUARANTEED.

CALL DIGGERS HOTLINE 1-800-242-8511 TOLL FREE WIS STATUTE 182.0175(1974) REQUIRES MIN. 3 WORK DAYS NOTICE BEFORE YOU EXCAVATE MILW. AREA 259-1181

**♯≥SIGMA** www.thesigmagroup.com 1300 West Canal Street Milwaukee, WI 53233 Phone: 414-643-4200 Fax: 414-643-4210

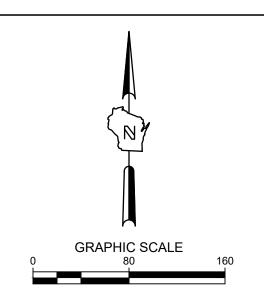

HLANDS

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ISSUANCE DATE PLAN COMMISSION SUBMITTAL 4/26/2024

NO. REVISION DATE

PROJECT NO: 21882 DESIGN DATE: PLOT DATE: 2024.05.17 DRAWN BY: CHECKED BY: APPROVED BY: PJI SHEET NO:

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PROPERTY LINE

SECTION 1/4 SECTION LINE

EASEMENT CHAIN LINK FENCE —X——X—— - $\bigcirc$ - $\bigcirc$ **GUARD RAIL** METAL FENCE \_\_\_\_ WOOD FENCE TREE LINE —— OH —— OVERHEAD UTILITY LINE ELECTRIC TELEPHONE FIBER OPTIC CABLE TV SANITARY SEWER FORCE MAIN STORM SEWER WATER MAIN GAS **EXISTING CONTOUR** \_\_\_\_ WET \_\_\_\_ WETLAND ——FP——— FLOODPLAIN **WH** UNKNOWN MANHOLE IRON PIPE FOUND/SET S SANITARY MANHOLE REBAR FOUND/SET ⑤ STORM MANHOLE © ELECTRIC MANHOLE **⊙**PK PK NAIL FOUND/SET MISD MANHOLE SPIKE/NAIL ① TELEPHONE MANHOLE ■ MONUMENT BENCHMARK CATCH BASIN ─o SIGN CATCH BASIN (ROUND) DARKING METER ROOF DRAIN ( )8" DECIDUOUS TREE ) CULVERT END \*CONIFEROUS TREE HYDRANT WATER VALVE BUSH ₩ GAS VALVE POST G GAS METER SOIL BORING

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TRAFFIC SIGNAL

LIGHT POLE

Ø UTILITY POLE

 $\longleftarrow$  GUY WIRE

GUY POLE

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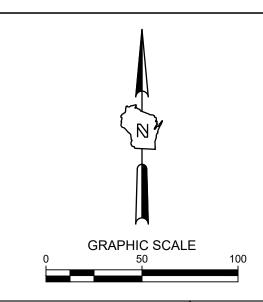
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MILW. AREA 259-1181

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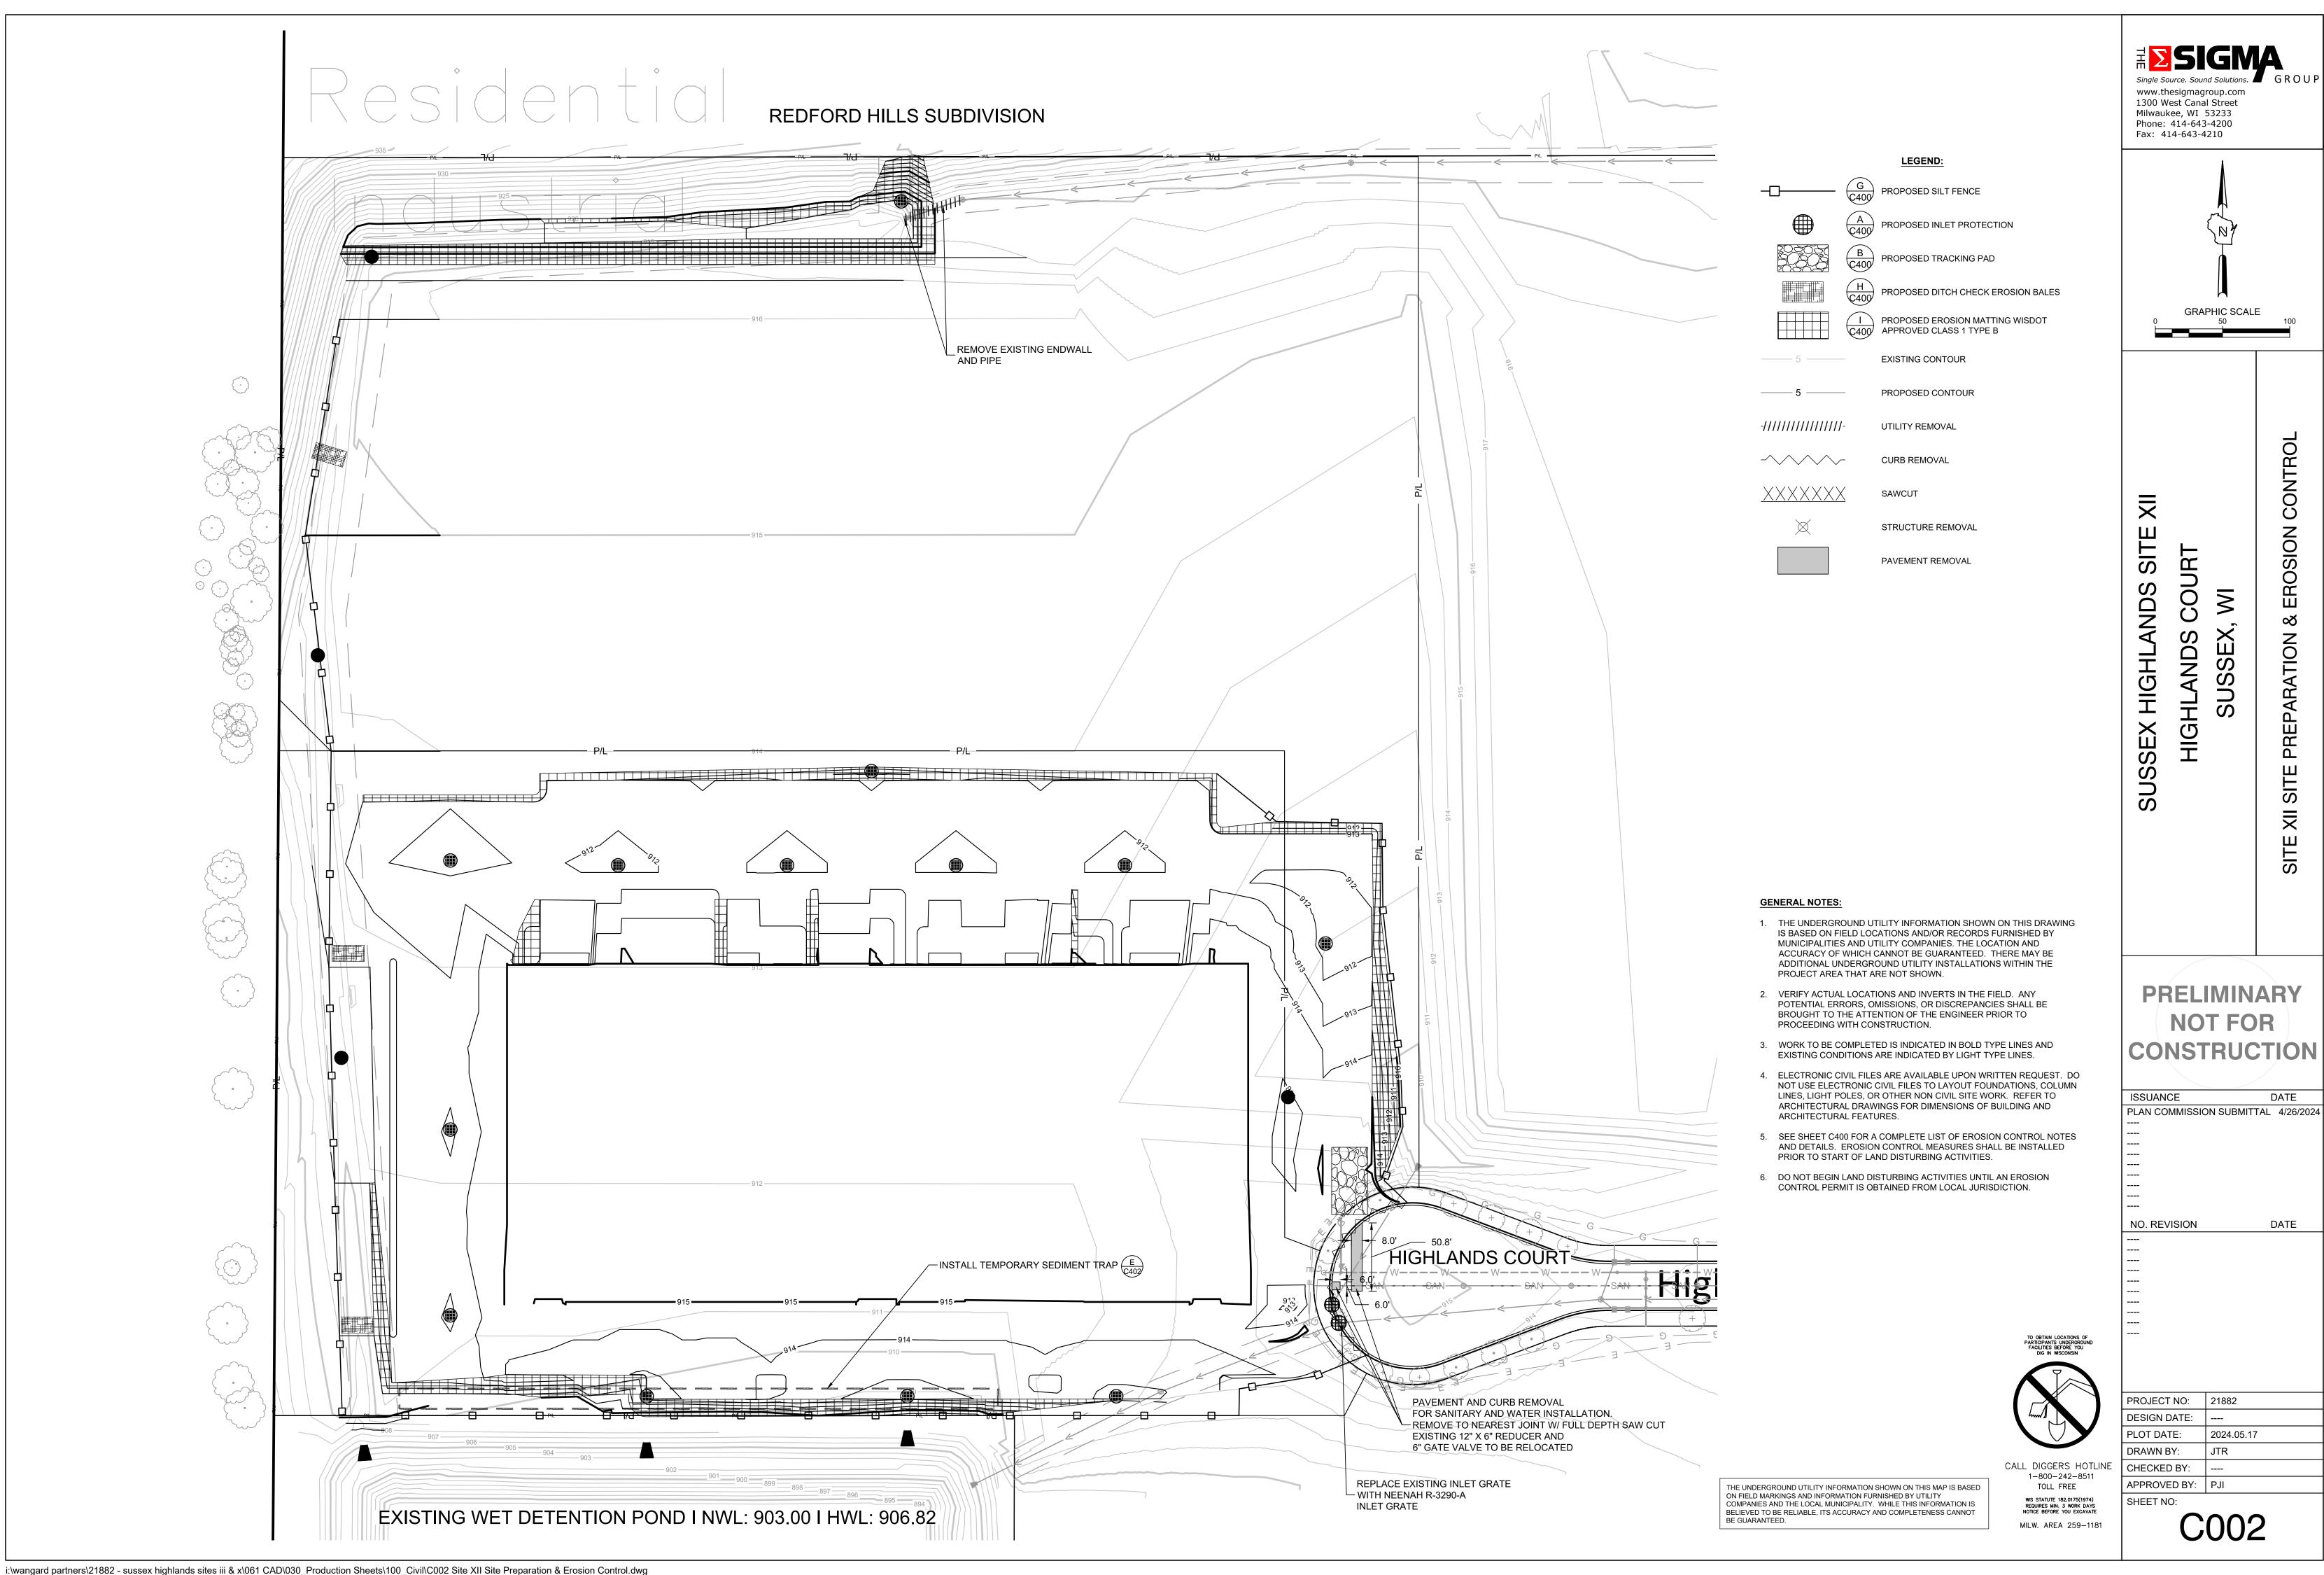
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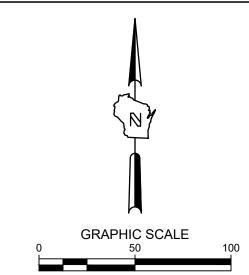
ISSUANCE DATE PLAN COMMISSION SUBMITTAL 4/26/2024 NO. REVISION DATE

PROJECT NO: 21882 DESIGN DATE: PLOT DATE: 2024.05.17 DRAWN BY: CALL DIGGERS HOTLINE 1-800-242-8511 CHECKED BY: APPROVED BY: PJI TOLL FREE WIS STATUTE 182.0175(1974) REQUIRES MIN. 3 WORK DAYS NOTICE BEFORE YOU EXCAVATE SHEET NO:



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CONTROL EROSION

HIGHLANDS

**PREPARATION** 

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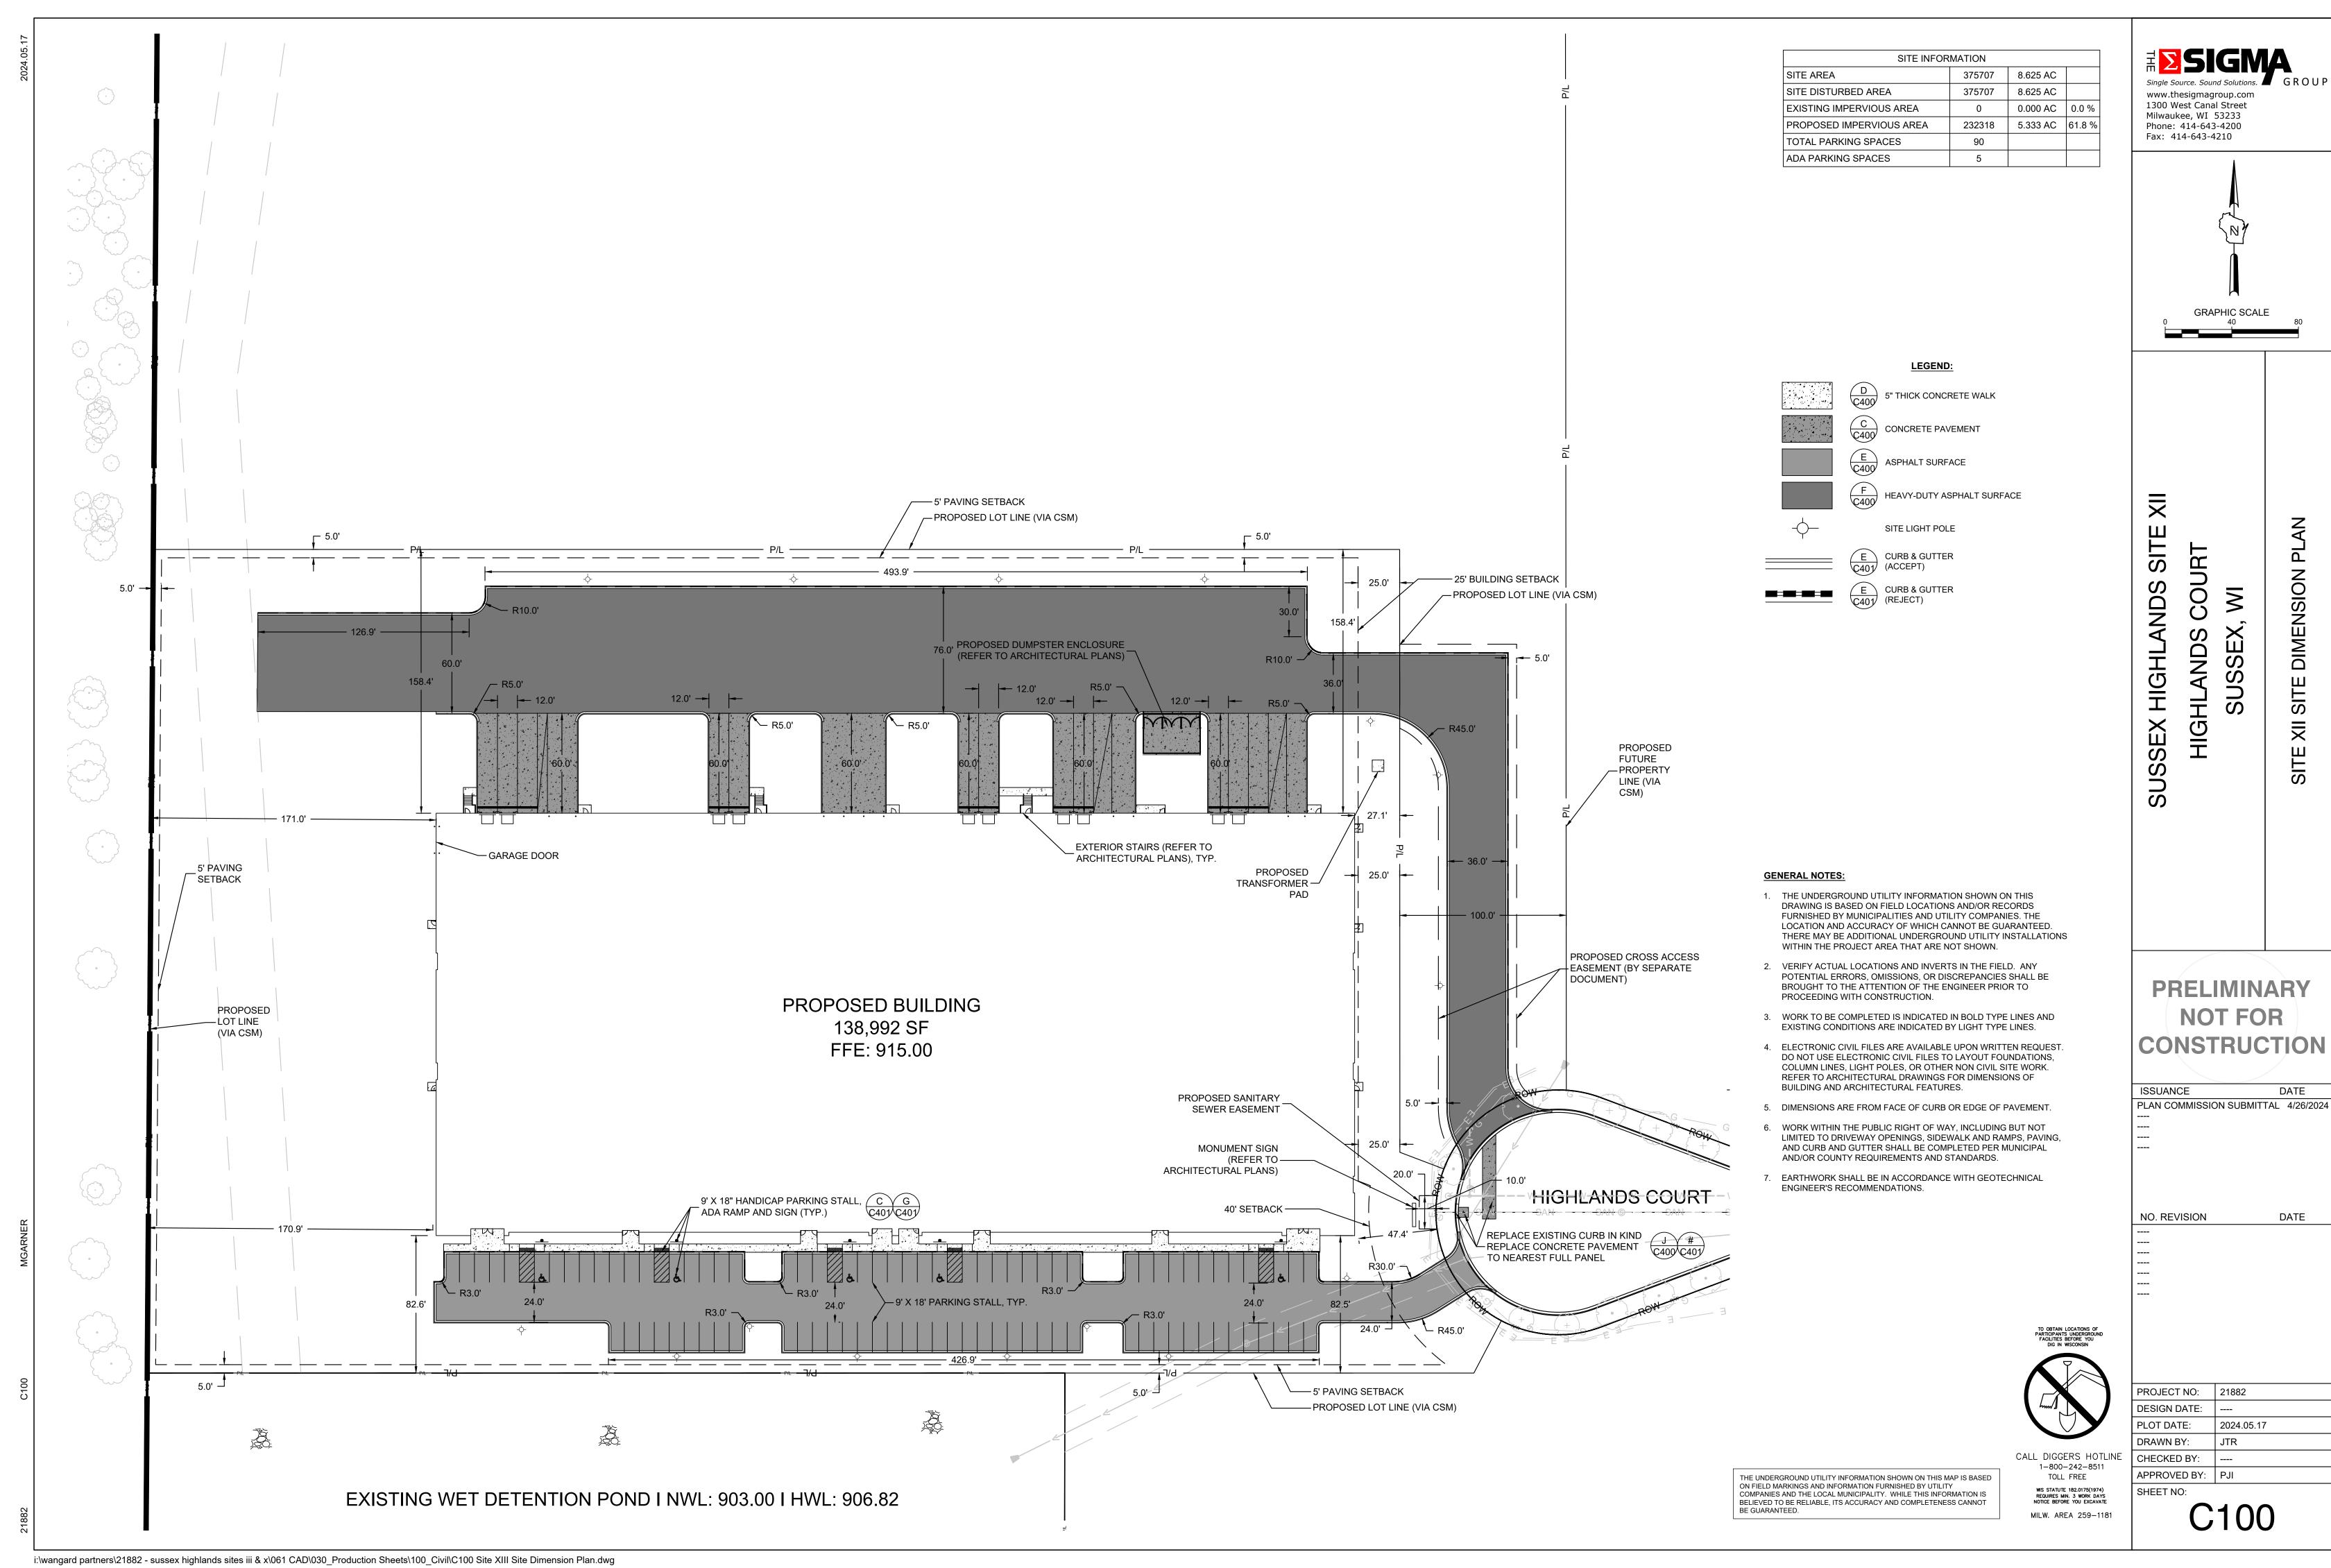
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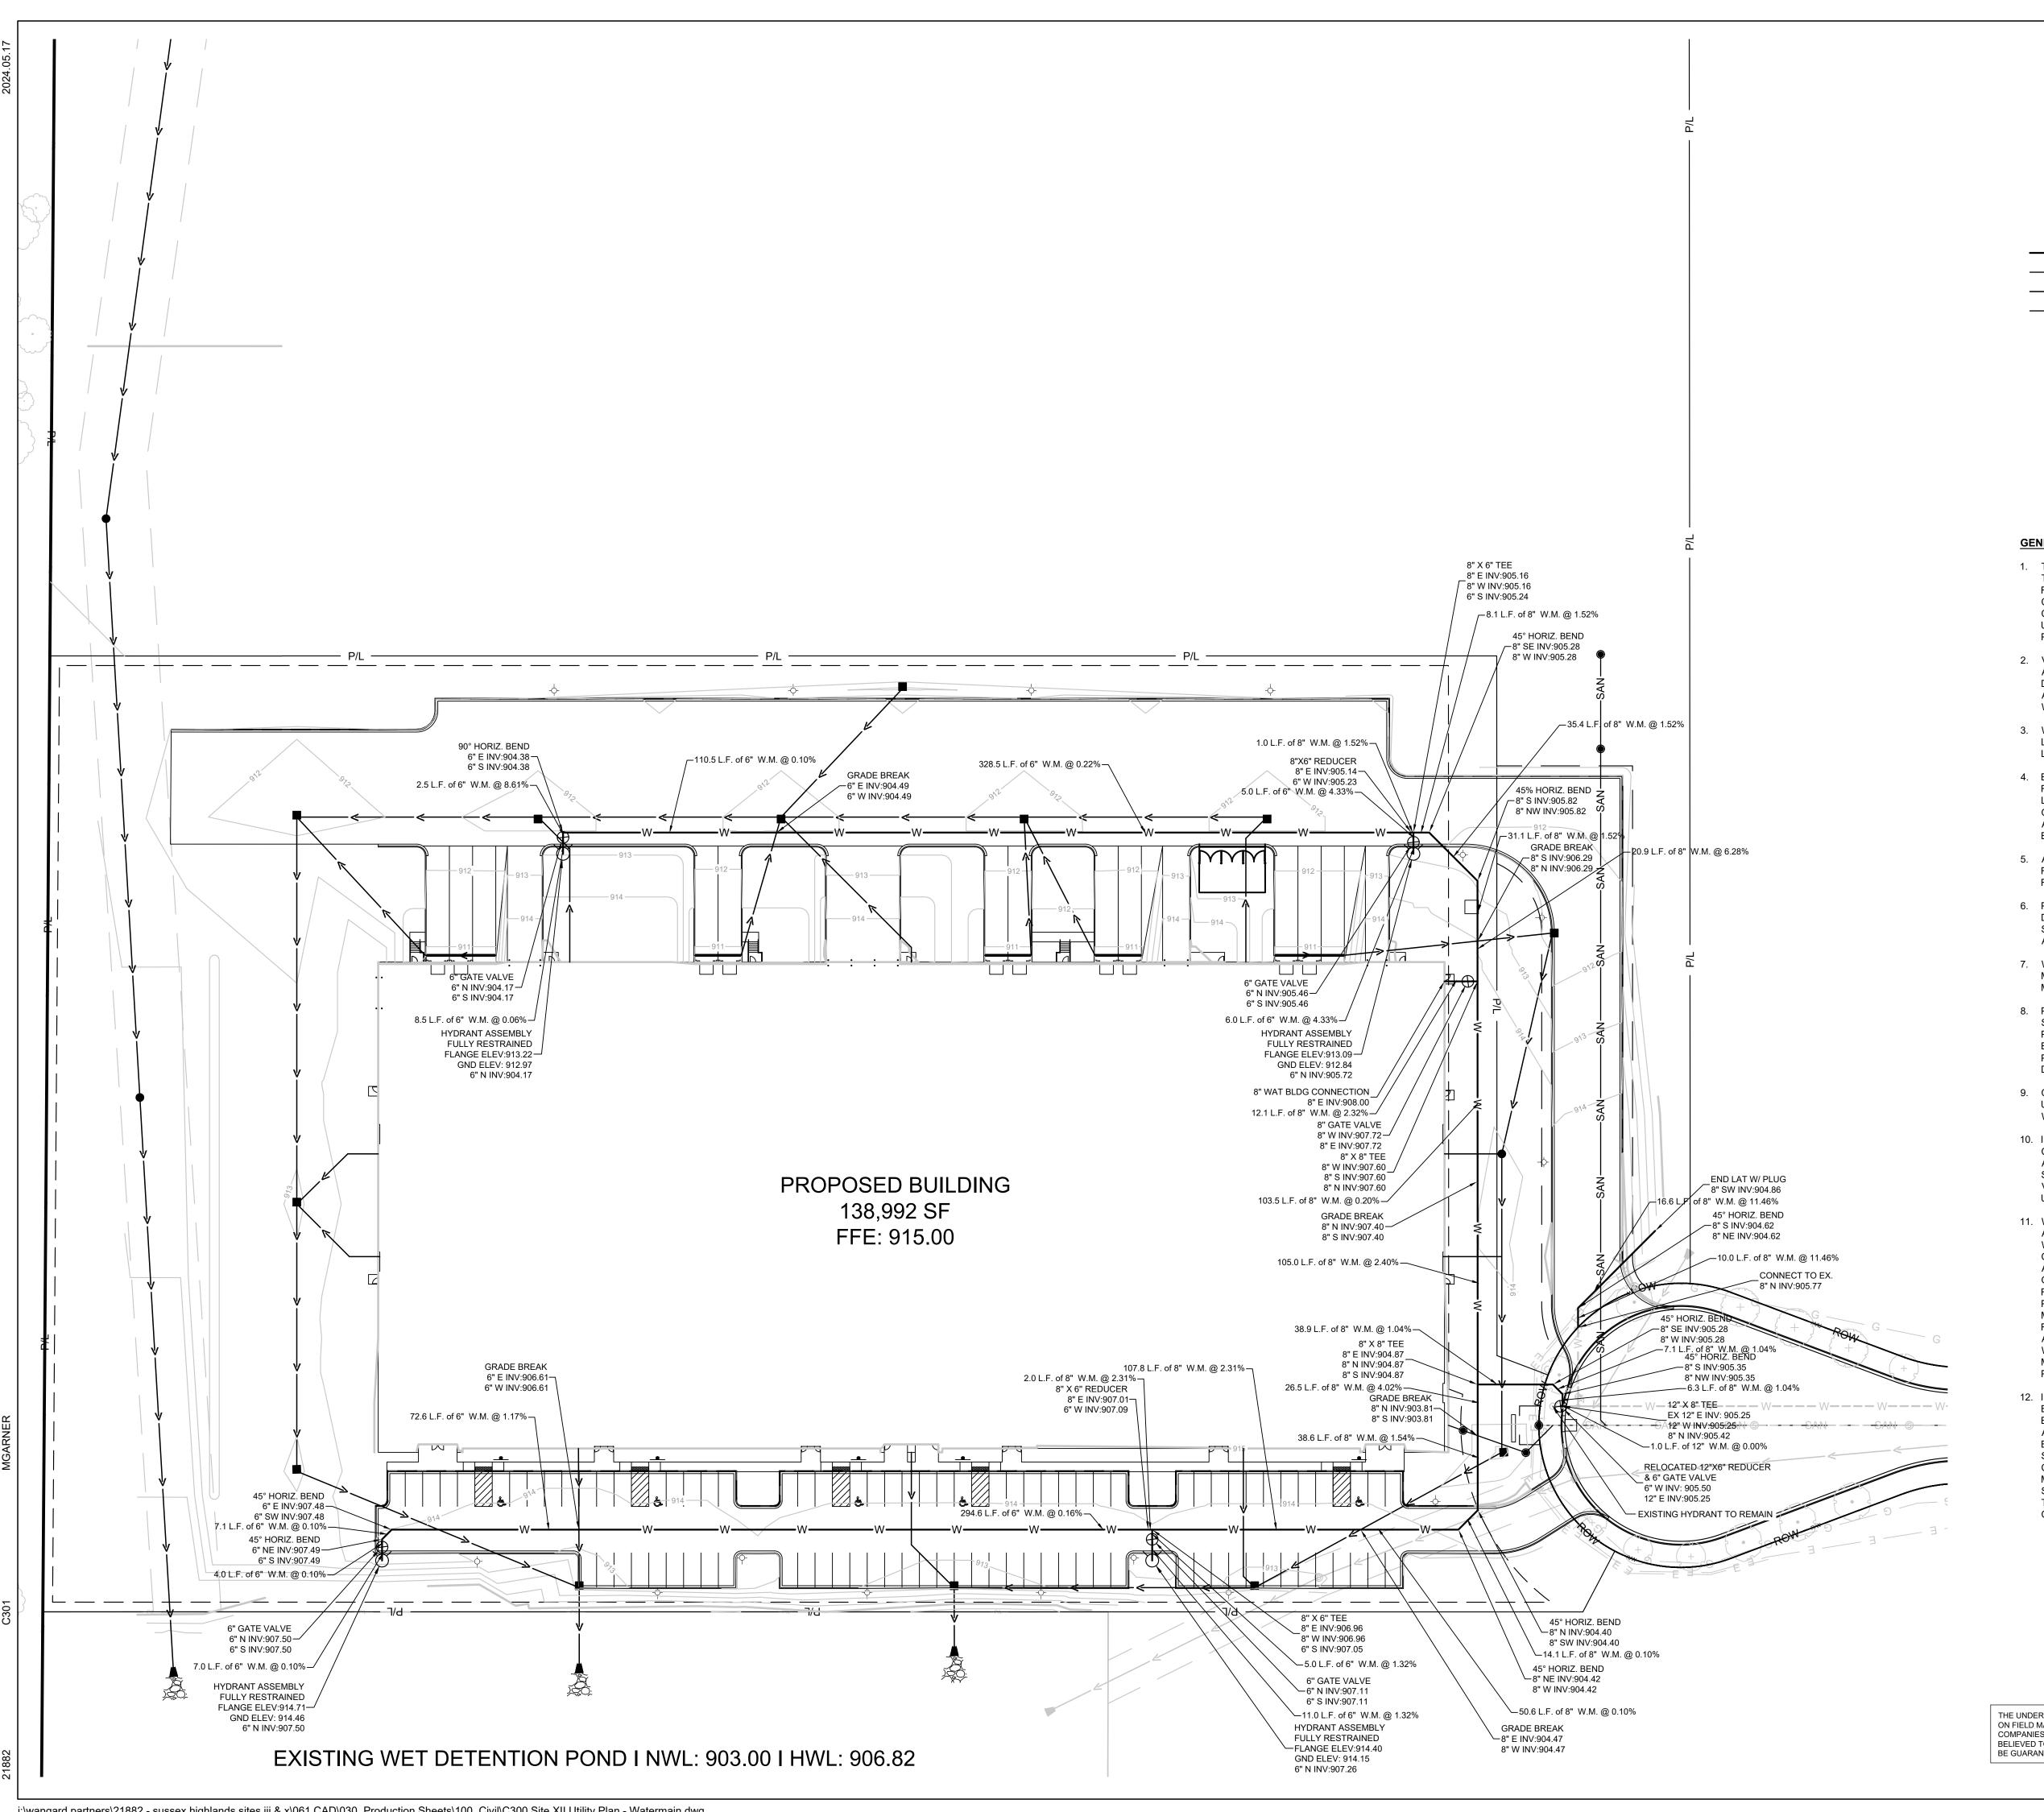
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ISSUANCE

PROJECT NO: 21882 DESIGN DATE: PLOT DATE: DRAWN BY: CHECKED BY:

2024.05.17 APPROVED BY: PJI SHEET NO:







PROPOSED WATER SERVICE PROPOSED SANITARY SERVICE PROPOSED STORM SEWER PROPOSED DRAIN TILE (UNDERDRAIN)

PROPOSED STORM INLET

PROPOSED STORM MANHOLE PROPOSED FLARED END SECTION

PROPOSED SANITARY MANHOLE

PROPOSED HYDRANT ASSEMBLY

## **GENERAL NOTES:**

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- 2. VERIFY ACTUAL LOCATIONS AND INVERTS IN THE FIELD. ANY POTENTIAL ERRORS, OMISSIONS, OR DISCREPANCIES SHALL BE BROUGHT TO THE ATTENTION OF THE ENGINEER PRIOR TO PROCEEDING WITH CONSTRUCTION.
- 3. WORK TO BE COMPLETED IS INDICATED IN BOLD TYPE LINES AND EXISTING CONDITIONS ARE INDICATED BY LIGHT TYPE LINES.
- 4. ELECTRONIC CIVIL FILES ARE AVAILABLE UPON WRITTEN REQUEST. DO NOT USE ELECTRONIC CIVIL FILES TO LAYOUT FOUNDATIONS, COLUMN LINES, LIGHT POLES, OR OTHER NON CIVIL SITE WORK. REFER TO ARCHITECTURAL DRAWINGS FOR DIMENSIONS OF BUILDING AND ARCHITECTURAL FEATURES.
- 5. ALL UTILITIES WITHIN 5 FEET OF PAVED AREAS SHALL REQUIRE GRANULAR BACKFILL. SLURRY BACKFILL IS REQUIRED FOR ALL WORK IN PUBLIC RIGHT OF WAY.
- 6. PRIVATE STORM INLETS IN PAVEMENT SHALL REQUIRE DRAIN TILE STUBS OF 10 FEET IN TWO DIRECTIONS FOR SUBDRAINAGE. RIM GRADE FOR STORM INLETS IN CURB AND GUTTER ARE FLOW LINE GRADES.
- 7. WORK IN PUBLIC RIGHT OF WAY SHALL FOLLOW MATERIAL AND INSTALLATION REQUIREMENTS PER MUNICIPAL AND/OR COUNTY.
- 8. PRIVATE STORM SEWER 12-INCH DIAMETER OR LARGER SHALL BE HDPE. BELOW 12-INCH DIAMETER SHALL BE PVC SDR-35 ASTM D3034. PRIVATE WATER MAIN SHALL BE CLASS 235 DR 18 PVC CONFORMING TO AWWA C-900. PRIVATE SANITARY SEWER SHALL BE PVC SDR-35 ASTM
- 9. COORDINATE FINAL LOCATION AND DESIGN OF PRIVATE UTILITY SERVICES (ELECTRIC, GAS, PHONE, CABLE) WITH UTILITY COMPANIES.
- 10. IF PROJECT IS DESIGN BUILD MEP. THE GENERAL CONTRACTOR IS REQUIRED TO PROVIDE FINAL SEWER AND WATER DESIGN SHOWING LOCATION, INVERTS AND SIZES TO THE ENGINEER FOR FINAL REVIEW AND VERIFICATION PRIOR TO STARTING UNDERGROUND UTILITY CONSTRUCTION.
- 11. WATER MAIN CONNECTION: TAP WATER MAIN WITH SIZE AND LOCATION INDICATED ON PLAN IN ACCORDANCE WITH LOCAL WATER UTILITY REQUIREMENTS. COORDINATE CONNECTION WITH LOCAL WATER UTILITY. ALL JOINTS HALL BE RESTRAINED FROM CONNECTION OF WATER MAIN TO BUILDING WALL. SUBMIT JOINT RESTRAINT DETAILS FOR ALL JOINT TYPES INCLUDING PUSH-ON AND MECHANICAL CONNECTIONS. INSTALL MEGA-LUG OR APPROVED EQUAL TIGHT TO WALL FOR RESTRAINT FOR ALL BUILDING WALL PENETRATIONS AS APPROVED BY LOCAL PLUMBING INSPECTOR AND WATER UTILITY. INSTALL THRUST BLOCKING AND MEGA-LUG AT BEND BELOW FLOOR FOR ALL FLOOR PENETRATIONS.
- 12. INSTALL JOINT RESTRAINT AND CONCRETE THRUST BLOCKS AT ALL OFFSET FITTINGS (TEES, BENDS, DEAD ENDS, VALVES, REDUCERS) USING MEGA-LUG OR APPROVED EQUAL. CONCRETE THRUST BLOCKS SHALL BE INSTALLED PER FILE NO'S:44,45,46 FROM THE STANDARD SPECIFICATIONS FOR SEWER AND WATER CONSTRUCTION IN WISCONSIN. SEE DETAIL FOR MINIMUM LENGTH OF RESTRAINED JOINT REQUIRED. SUBMIT JOINT RESTRAINT DETAILS FOR ALL JOINT TYPES INCLUDING PUSH-ON AND MECHANICAL CONNECTIONS.



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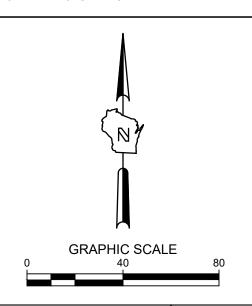
WIS STATUTE 182.0175(1974)

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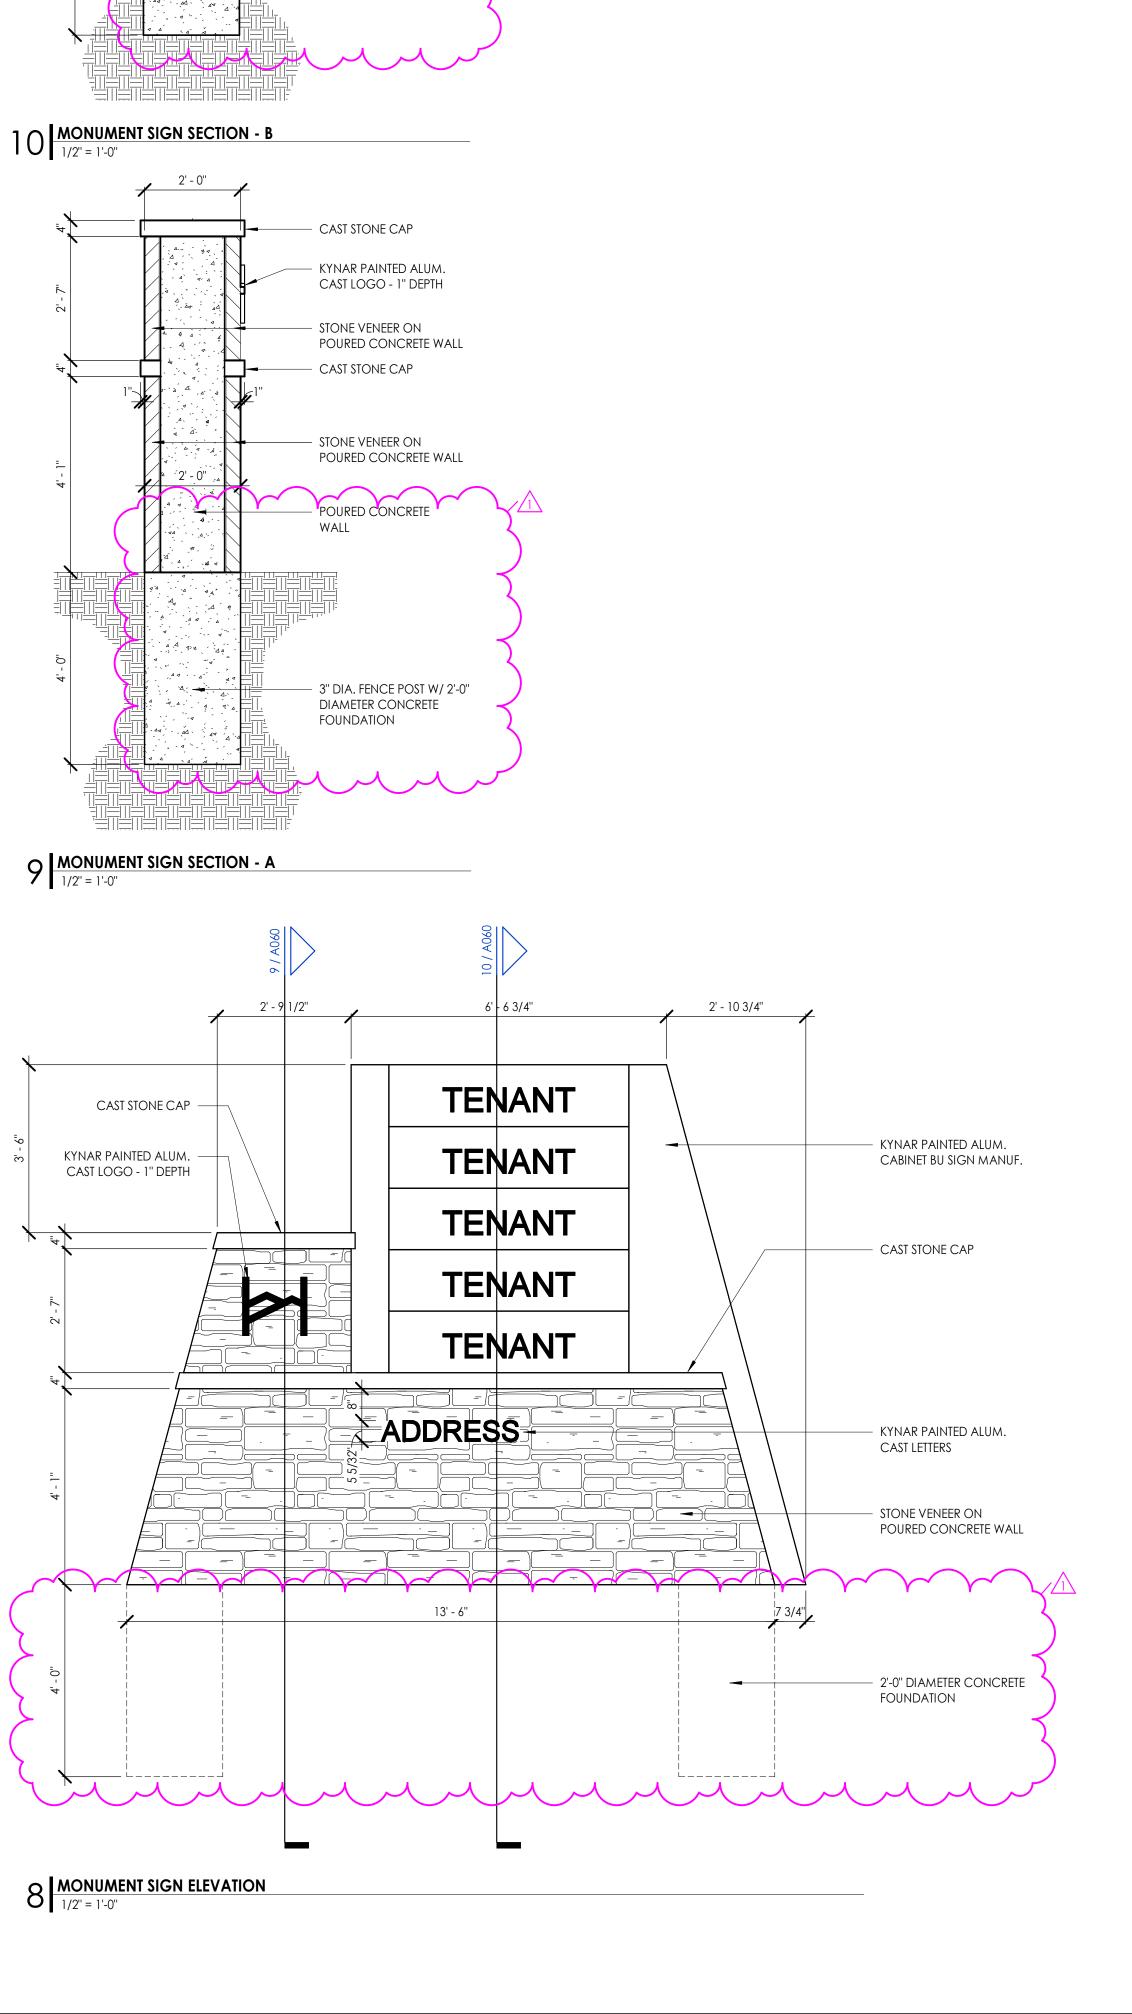
PLAN COMMISSION SUBMITTAL 4/26/2024

DATE

ISSUANCE

NO. REVISION DATE

PROJECT NO: 21882 DESIGN DATE: PLOT DATE: 2024.05.17 DRAWN BY: JTR CHECKED BY: APPROVED BY: | PJI SHEET NO:



KYNAR PAINTED ALUM.

CAST STONE CAP

CAST LETTERS

- STONE VENEER ON POURED CONCRETE WALL


- POURED CONCRETE

- 3" DIA. FENCE POST W/ 2'-0" DIAMETER CONCRETE


FOUNDATION

- KYNAR PAINTED ALUM.


CABINET BU SIGN MANUF.

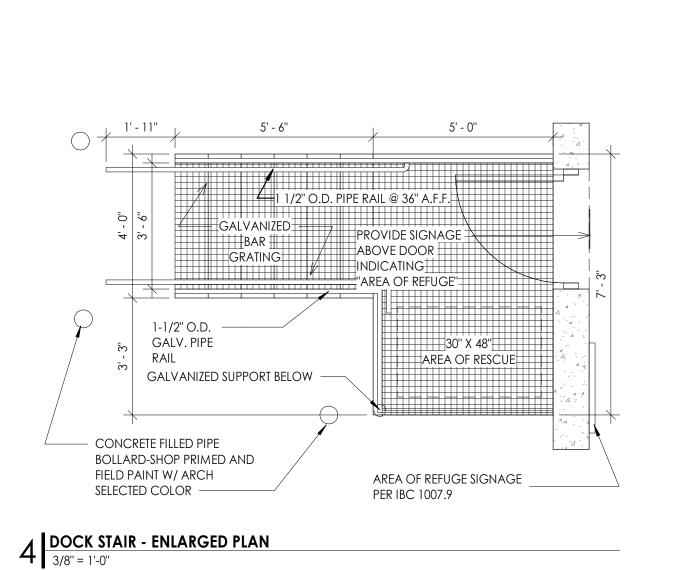


## 5 DOCK STAIR - ELEVATION 3/8" = 1'-0"

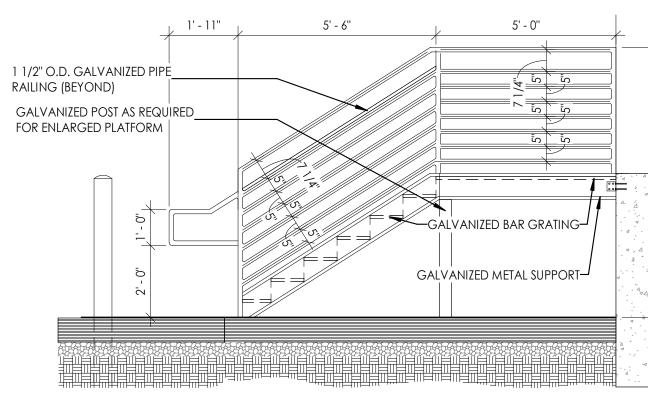

## 6 CONCRETE FILLED PIPE BOLLARD 1/2" = 1'-0"

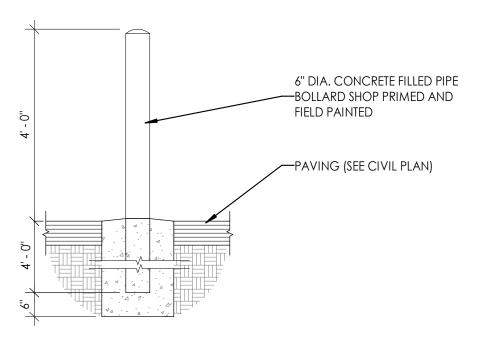

## 7 ENLARGED MONUMENT SIGN PLAN 1/2" = 1'-0"

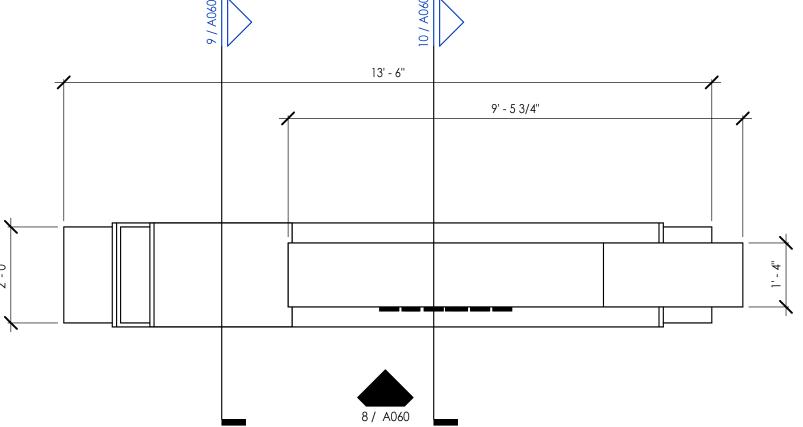

SHEET KEYNOTES

- 03-07 CONCRETE FILLED PIPE BOLLARD WITH YELLOW PLASTIC SLEEVE
- 03-13 CONCRETE CURB WHEEL STOP
- 32-02 8'-0" HIGH CHAIN LINK FENCE W/ WOVEN SCREENING 32-03 CHAIN LINK FENCE GATE W/ WOVEN SCREENING

32-02

- REINFORCED

CONCRETE SLAB



215 N. WATER STREET, SUITE 250 MILWAUKEE, WI 53202 T 414.277.9700 | F 414.277.9705 spsarchitects.com







PROJECT

PROPOSED BUILDING FOR:



WANGARD HIGHLANDS - SITE XII

SUSSEX, WISCONSIN

OWNER



REVISIONS

1 MUNICIPAL REVIEW COMMENTS 05/20/2024


INFORMATION

PROJECT ARCHITECT PROJECT MANAGER SJC 240205 PROJECT NUMBER ISSUED FORMUNICIPAL REVIEW COMMENTS

MAY 10, 2024

SHEET PROJECT SITE DETAILS

© STEPHEN PERRY SMITH ARCHITECTS, INC.

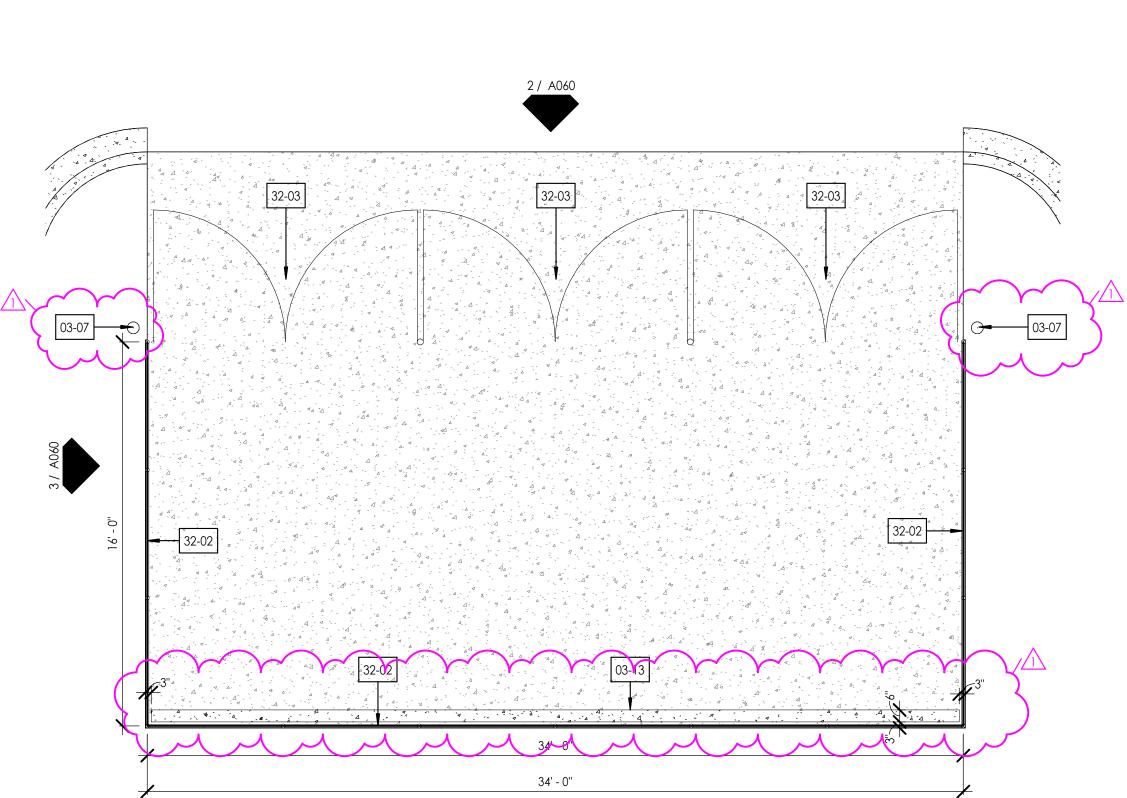

3" DIA. FENCE POST W/ 2'-0"


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DIAMETER CONCRETE

FOUNDATION

3 DUMPSTER ENCLOSURE - SIDE

2 DUMPSTER ENCLOSURE - FRONT
1/4" = 1'-0"

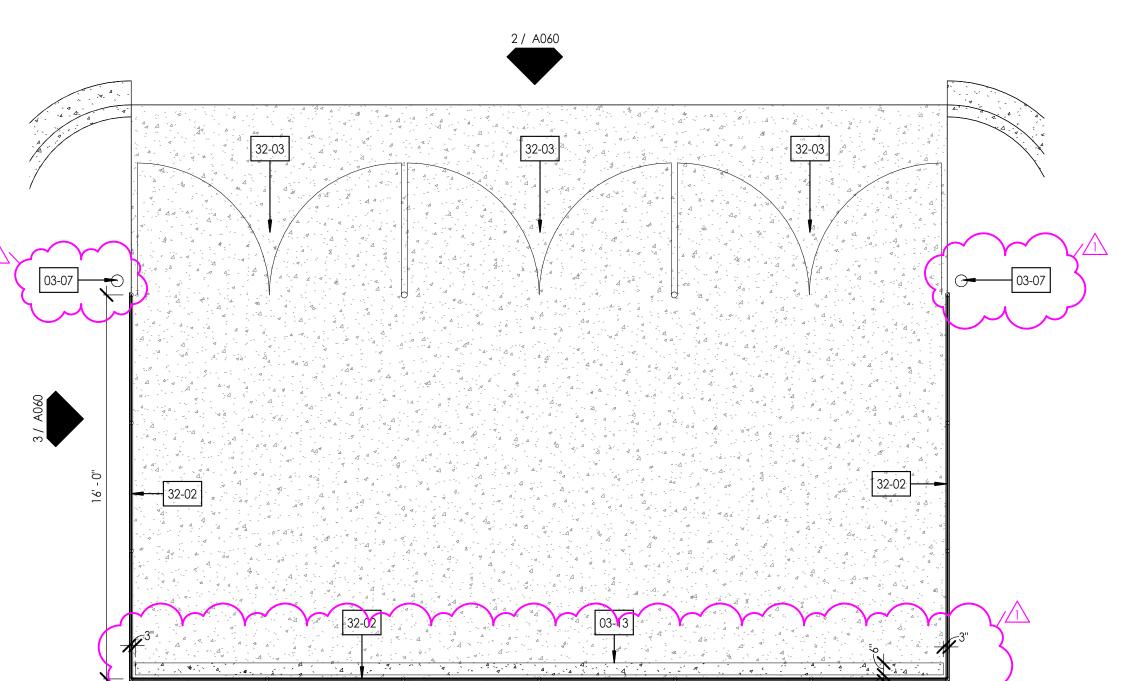


1 ENLARGED PLAN - DUMPSTER ENCLOSURE

- REINFORCED CONCRETE SLAB

34' - 0"

3" DIA. FENCE POST W/ 2'-0" DIAMETER CONCRETE

FOUNDATION

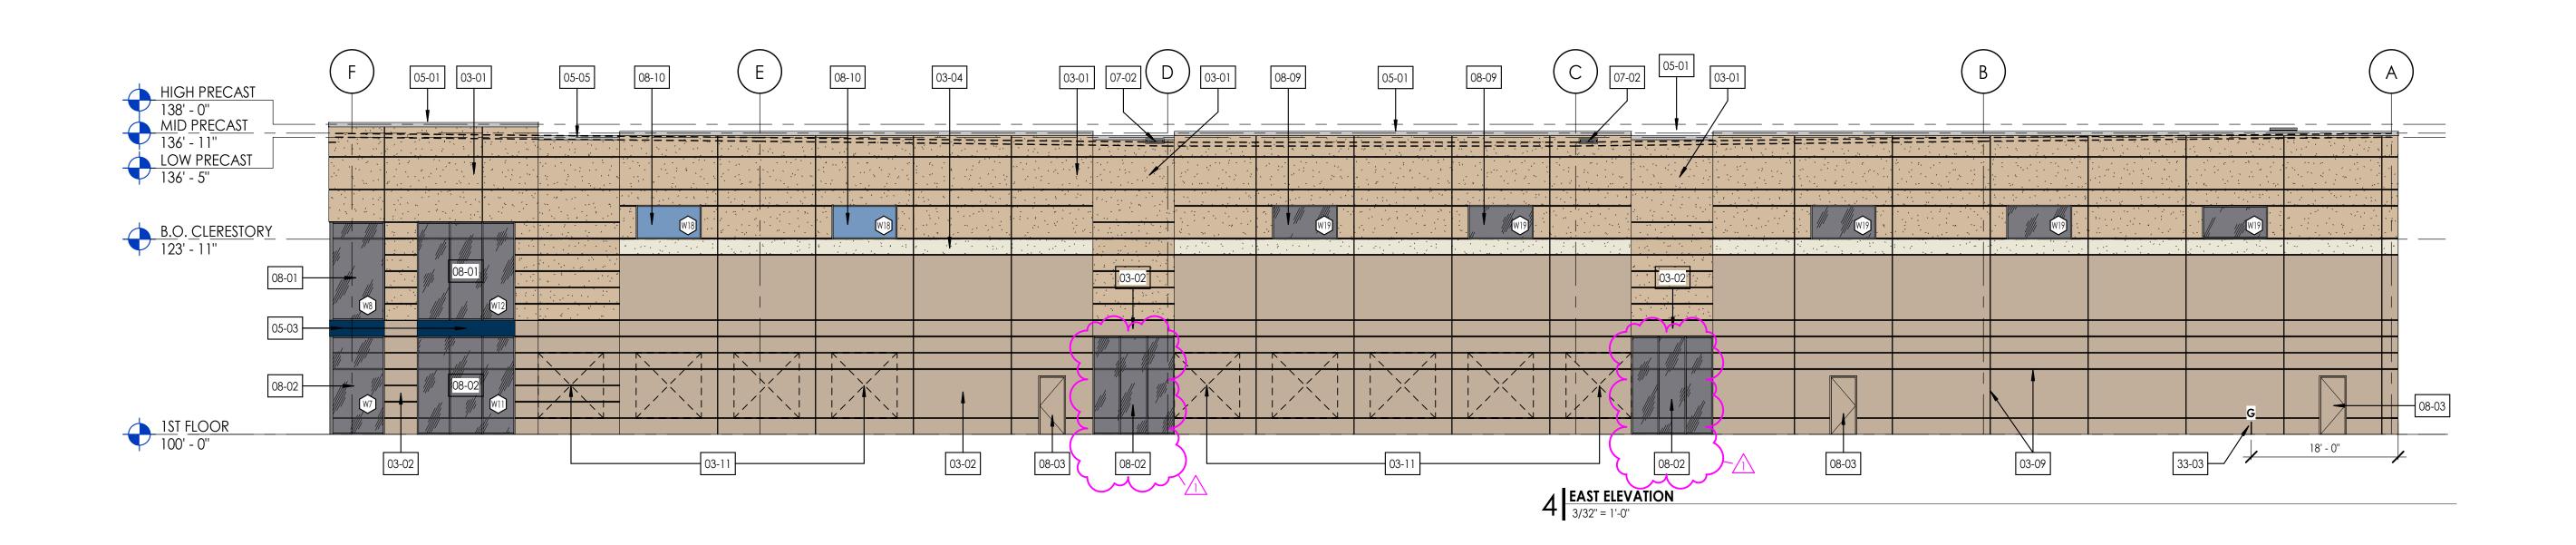

HIGH PRECAST 138' - 0" MID PRECAST 136' - 11" LOW PRECAST 136' - 5"

B.O. CLERESTORY 123' - 11"

05-03

## SHEET KEYNOTES

03-02

08-02

- 03-01 INSULATED PRECAST WALL PANEL PRECAST FINISH 3 (SANDBLAST)
- 03-02 INSULATED PRECAST WALL PANEL PRECAST FINISH 1 (EXPOSED AGGREGATE)
- 03-04 INSULATED PRECAST WALL PANEL PRECAST FINISH 2 (ACID WASHED) 03-09 HORIZONTAL AND VERTICAL REVEALS
- 03-11 FUTURE WINDOW KNOCKOUT
- 05-01 PREFINISHED METAL COPING (AM1)
- 05-03 PREFINISHED METAL PANEL (AM3) BLUE 05-05 PREFINISHED METAL GRAVEL STOP (AM1)
- 07-02 PREFINISHED METAL THRU-WALL SCUPPER (AM9) SEE DETAIL 26/A801
- 08-02 ALUMINUM STOREFRONT ENTRY SYSTEM (AM3, GL1, GL1T)

08-01 ALUMINUM STOREFRONT WINDOW SYSTEM (AM2, GL1)

08-03 INSULATED STEEL DOOR AND FRAME (EPT5) - DARK GRAY

08-09 ALUMINUM CLERESTORY WINDOW (AM2, GL1))

- 08-10 ALUMINUM CLERESTORY WINDOW W/ SPANDREL GLAZING (AM2, GL1S)
- 33-03 GAS LINE ENTRY LOCATION



215 N. WATER STREET, SUITE 250 MILWAUKEE, WI 53202

T 414.277.9700 | F 414.277.9705 spsarchitects.com





PROJECT

PROPOSED BUILDING FOR:



WANGARD HIGHLANDS - SITE XII

SUSSEX, WISCONSIN

OWNER




REVISIONS

NO. DESCRIPTION DATE
1 MUNICIPAL REVIEW COMMENTS 05/20/2024

05-01 07-02 03-01 7 08-09	05-05 03-01 08-09 8	08-09 03-01 9 08-09	05-01 03-01 08-10 03-09 08-10	138' - 0"
				136' - 11" LOW PRECAST 136' - 5"
				B.O. CLERESTORY 123' - 11"
W17 W13 W15 W17	03 <sub>02</sub>		03,02 W18	05-03 08-02
08-02 03-02 08-01	08-02	03-11	08-02 03-02 08-01 08-01	1ST FLOOR 100' - 0"

08-09

3 SOUTH ELEVATION - B

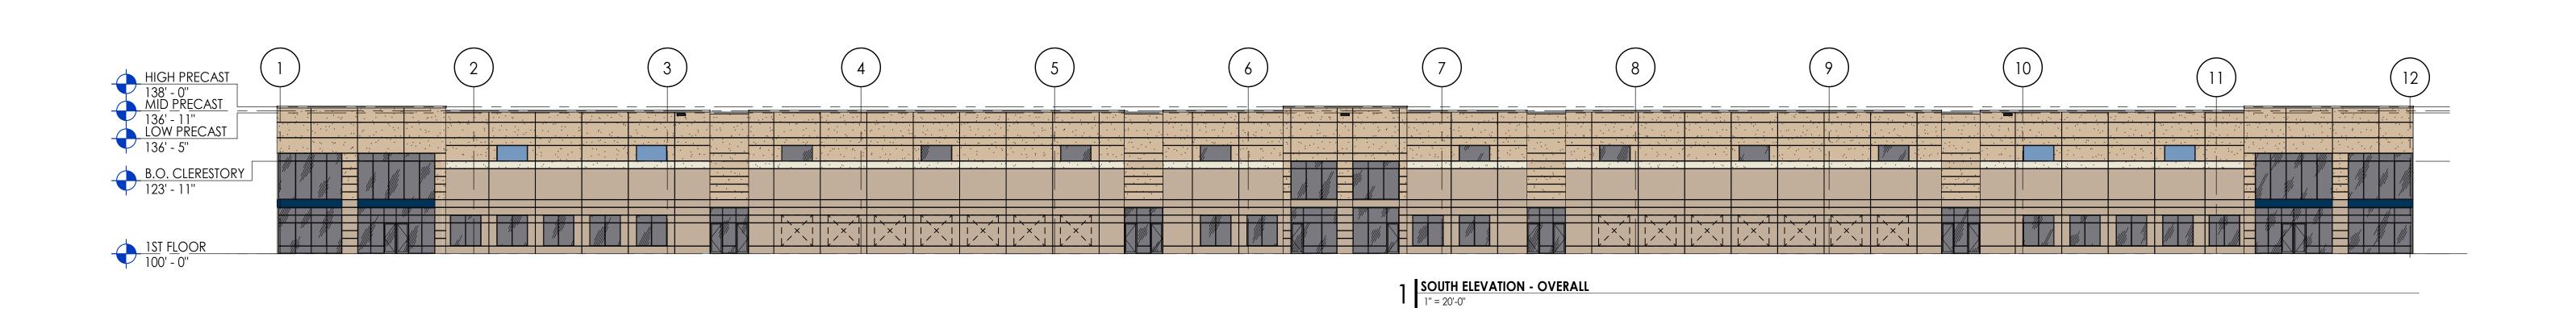


INFORMATION


PROJECT ARCHITECT SJC PROJECT MANAGER 240205 PROJECT NUMBER ISSUED FORMUNICIPAL REVIEW COMMENTS


MAY 10, 2024


SHEET BUILDING ELEVATIONS

© STEPHEN PERRY SMITH ARCHITECTS, INC

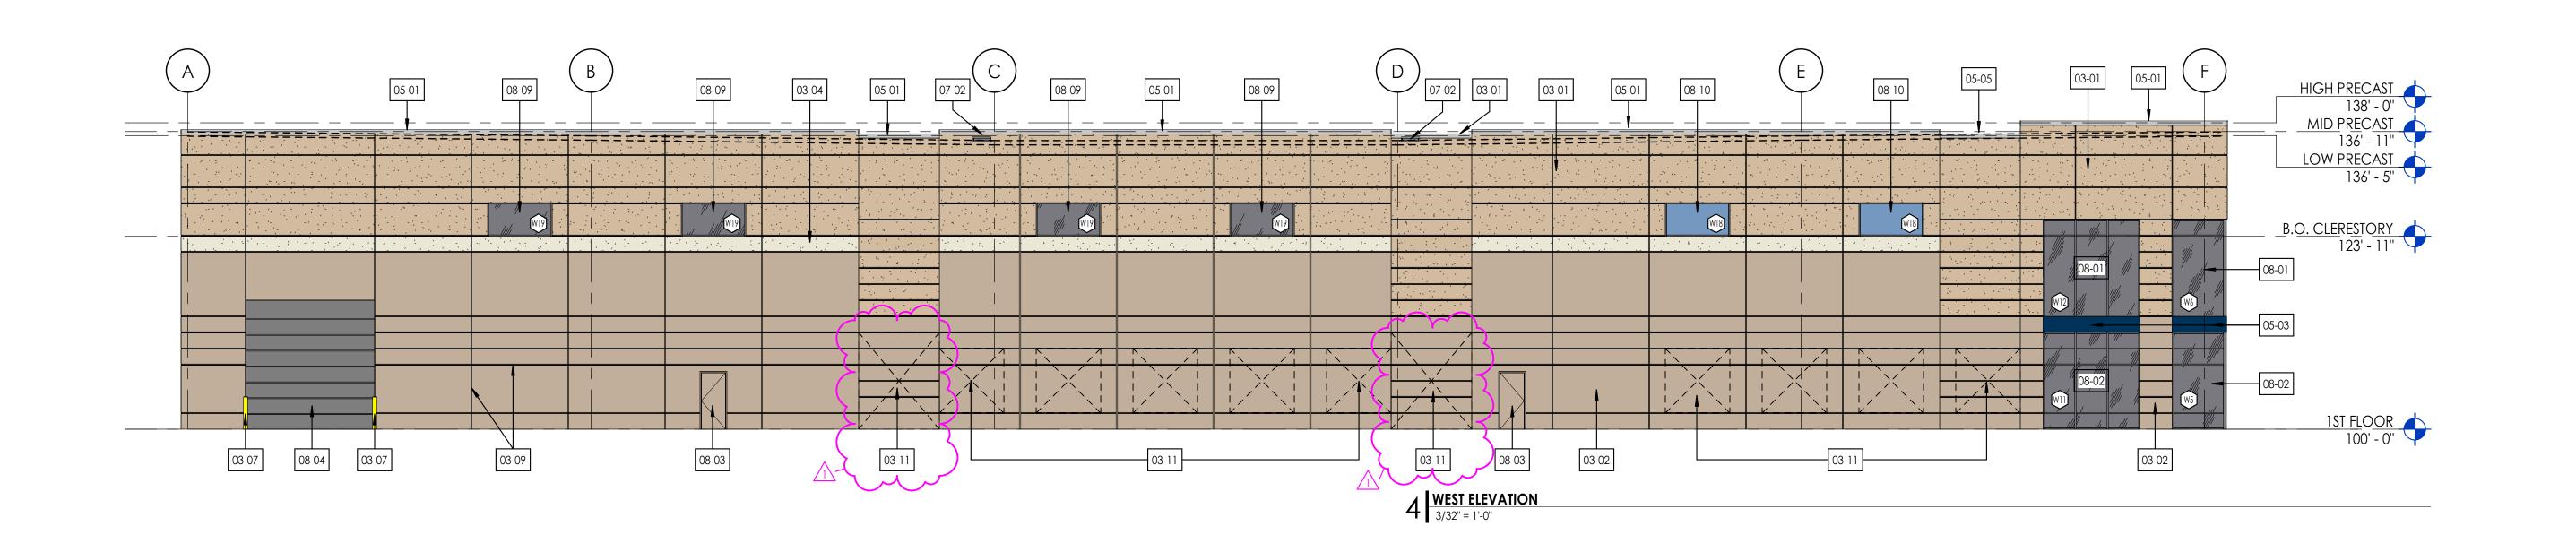

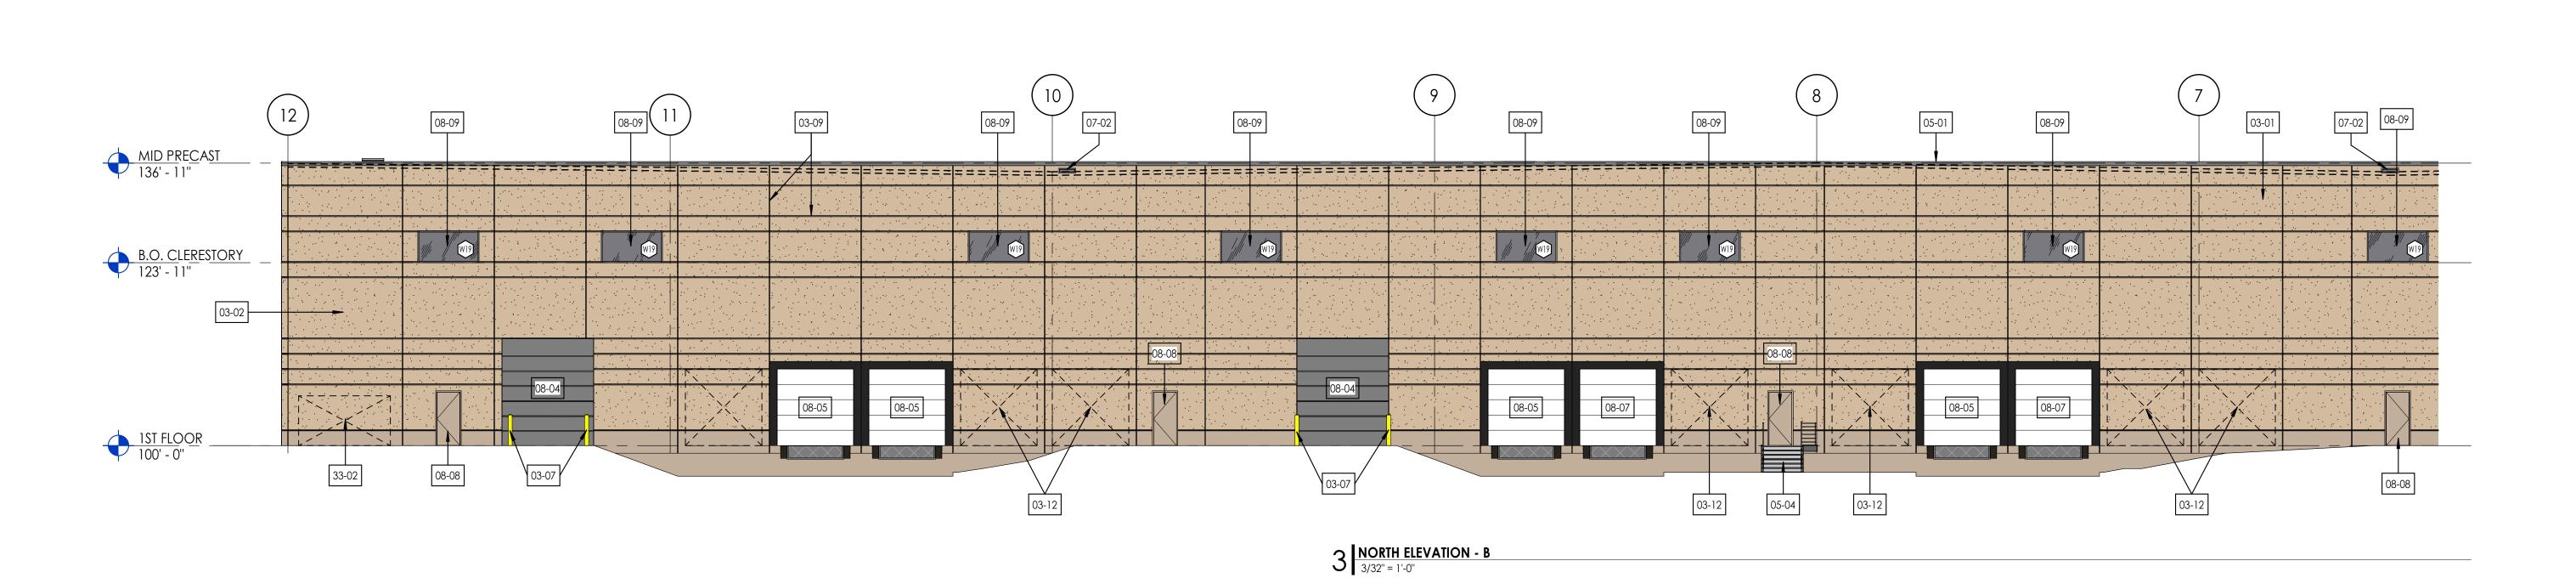

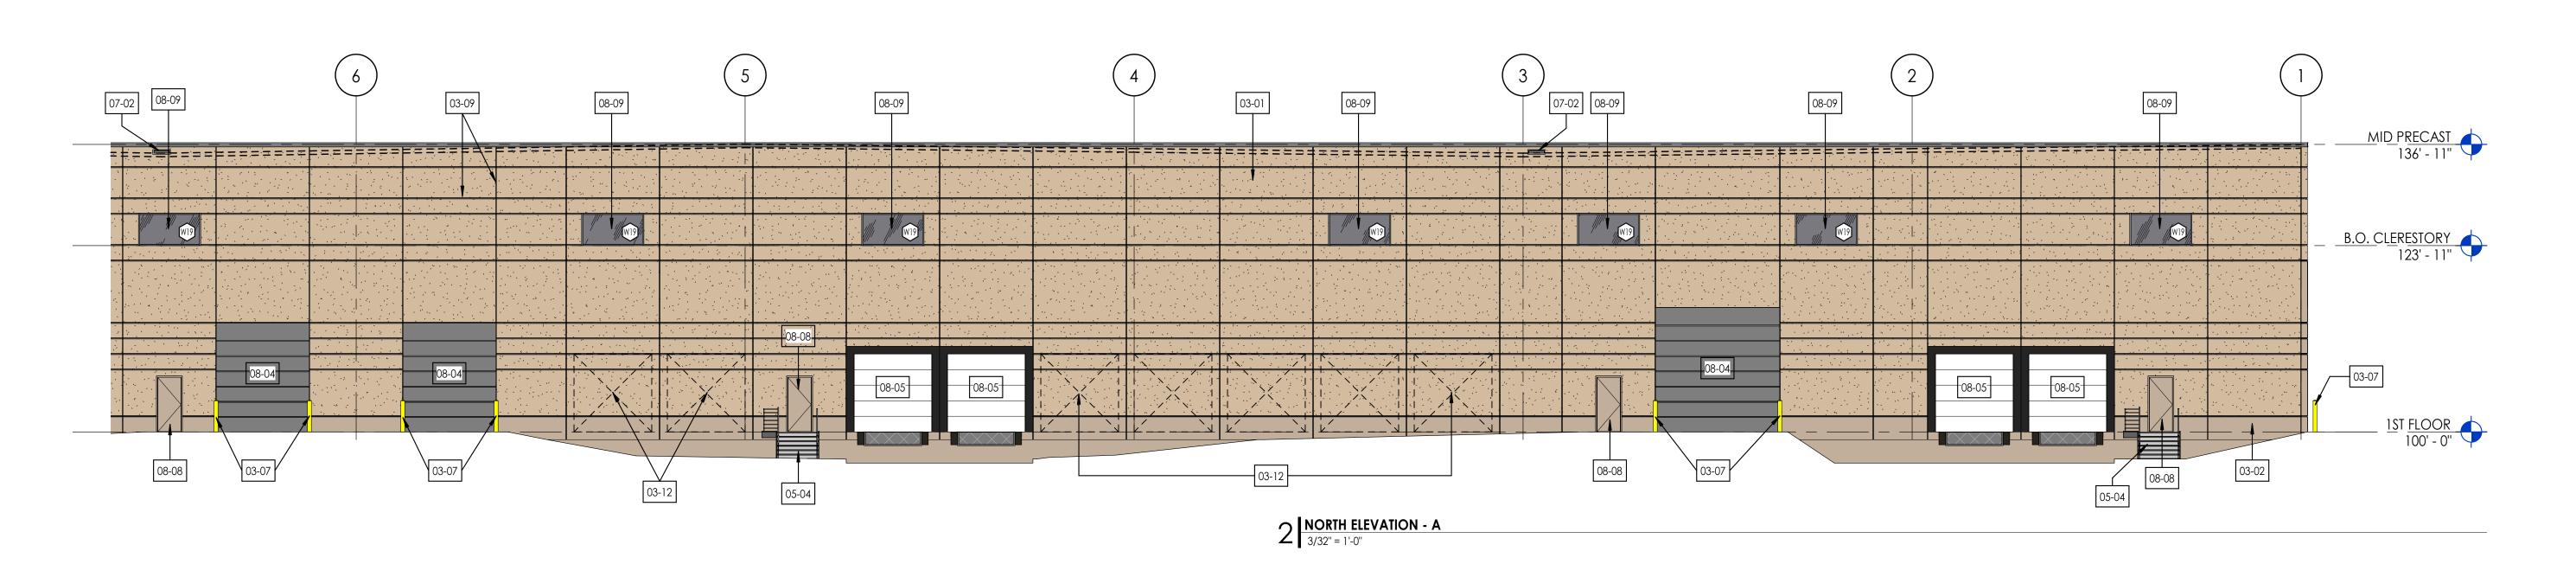

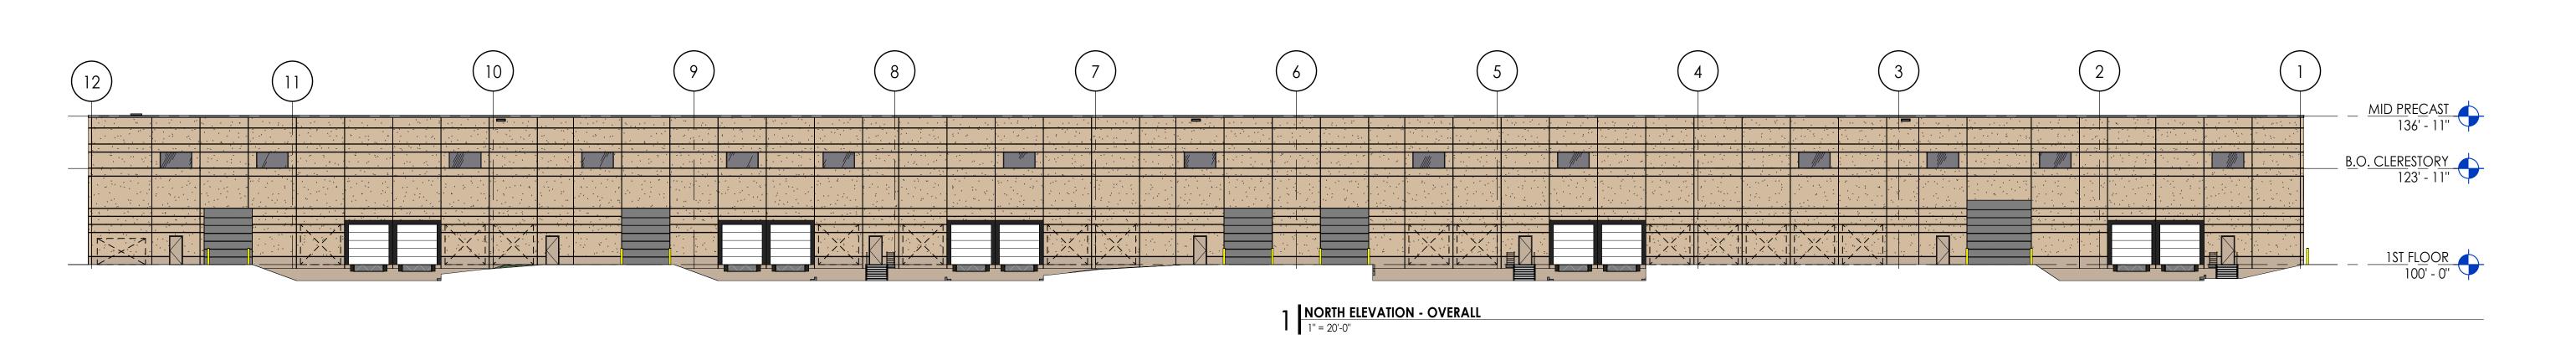

## SHEET KEYNOTES

- 03-01 INSULATED PRECAST WALL PANEL PRECAST FINISH 3 (SANDBLAST)
- 03-02 INSULATED PRECAST WALL PANEL PRECAST FINISH 1 (EXPOSED AGGREGATE)
- 03-04 INSULATED PRECAST WALL PANEL PRECAST FINISH 2 (ACID WASHED) 03-07 CONCRETE FILLED PIPE BOLLARD WITH YELLOW PLASTIC SLEEVE
- 03-09 HORIZONTAL AND VERTICAL REVEALS 03-11 FUTURE WINDOW KNOCKOUT
- 03-12 FUTURE DOCK DOOR KNOCKOUT
- 05-01 PREFINISHED METAL COPING (AM1)
- 05-03 PREFINISHED METAL PANEL (AM3) BLUE 05-04 DOCK STAIR - HOT DIPPED GALVANIZED METAL (AM8)
- 05-05 PREFINISHED METAL GRAVEL STOP (AM1) 07-02 PREFINISHED METAL THRU-WALL SCUPPER (AM9) - SEE DETAIL 26/A801
- 08-01 ALUMINUM STOREFRONT WINDOW SYSTEM (AM2, GL1)
- 08-02 ALUMINUM STOREFRONT ENTRY SYSTEM (AM3, GL1, GL1T) 08-03 INSULATED STEEL DOOR AND FRAME (EPT5) - DARK GRAY
- 08-04 INSULATED OVERHEAD DRIVE-IN DOOR (AM6) WHITE 08-05 INSULATED OVERHEAD DOCK DOOR WITH DOCK SEAL (AM7) - WHITE
- 08-07 'Z' GUARDS AT DOCK DOORS
- 08-08 INSULATED STEEL DOOR AND FRAME (EPT6) MEDIUM GRAY
- 08-09 ALUMINUM CLERESTORY WINDOW (AM2, GL1))
- 08-10 ALUMINUM CLERESTORY WINDOW W/ SPANDREL GLAZING (AM2, GL1S) 33-02 EXTERIOR MOUNTED SWITCH GEAR LOCATION



ARCHITECTS, INC.

215 N. WATER STREET, SUITE 250

MILWAUKEE, WI 53202

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PROPOSED BUILDING FOR:

PROJECT



WANGARD HIGHLANDS - SITE XII

SUSSEX, WISCONSIN

OWNER



REVISIONS

MUNICIPAL REVIEW COMMENTS 05/20/2024

INFORMATION


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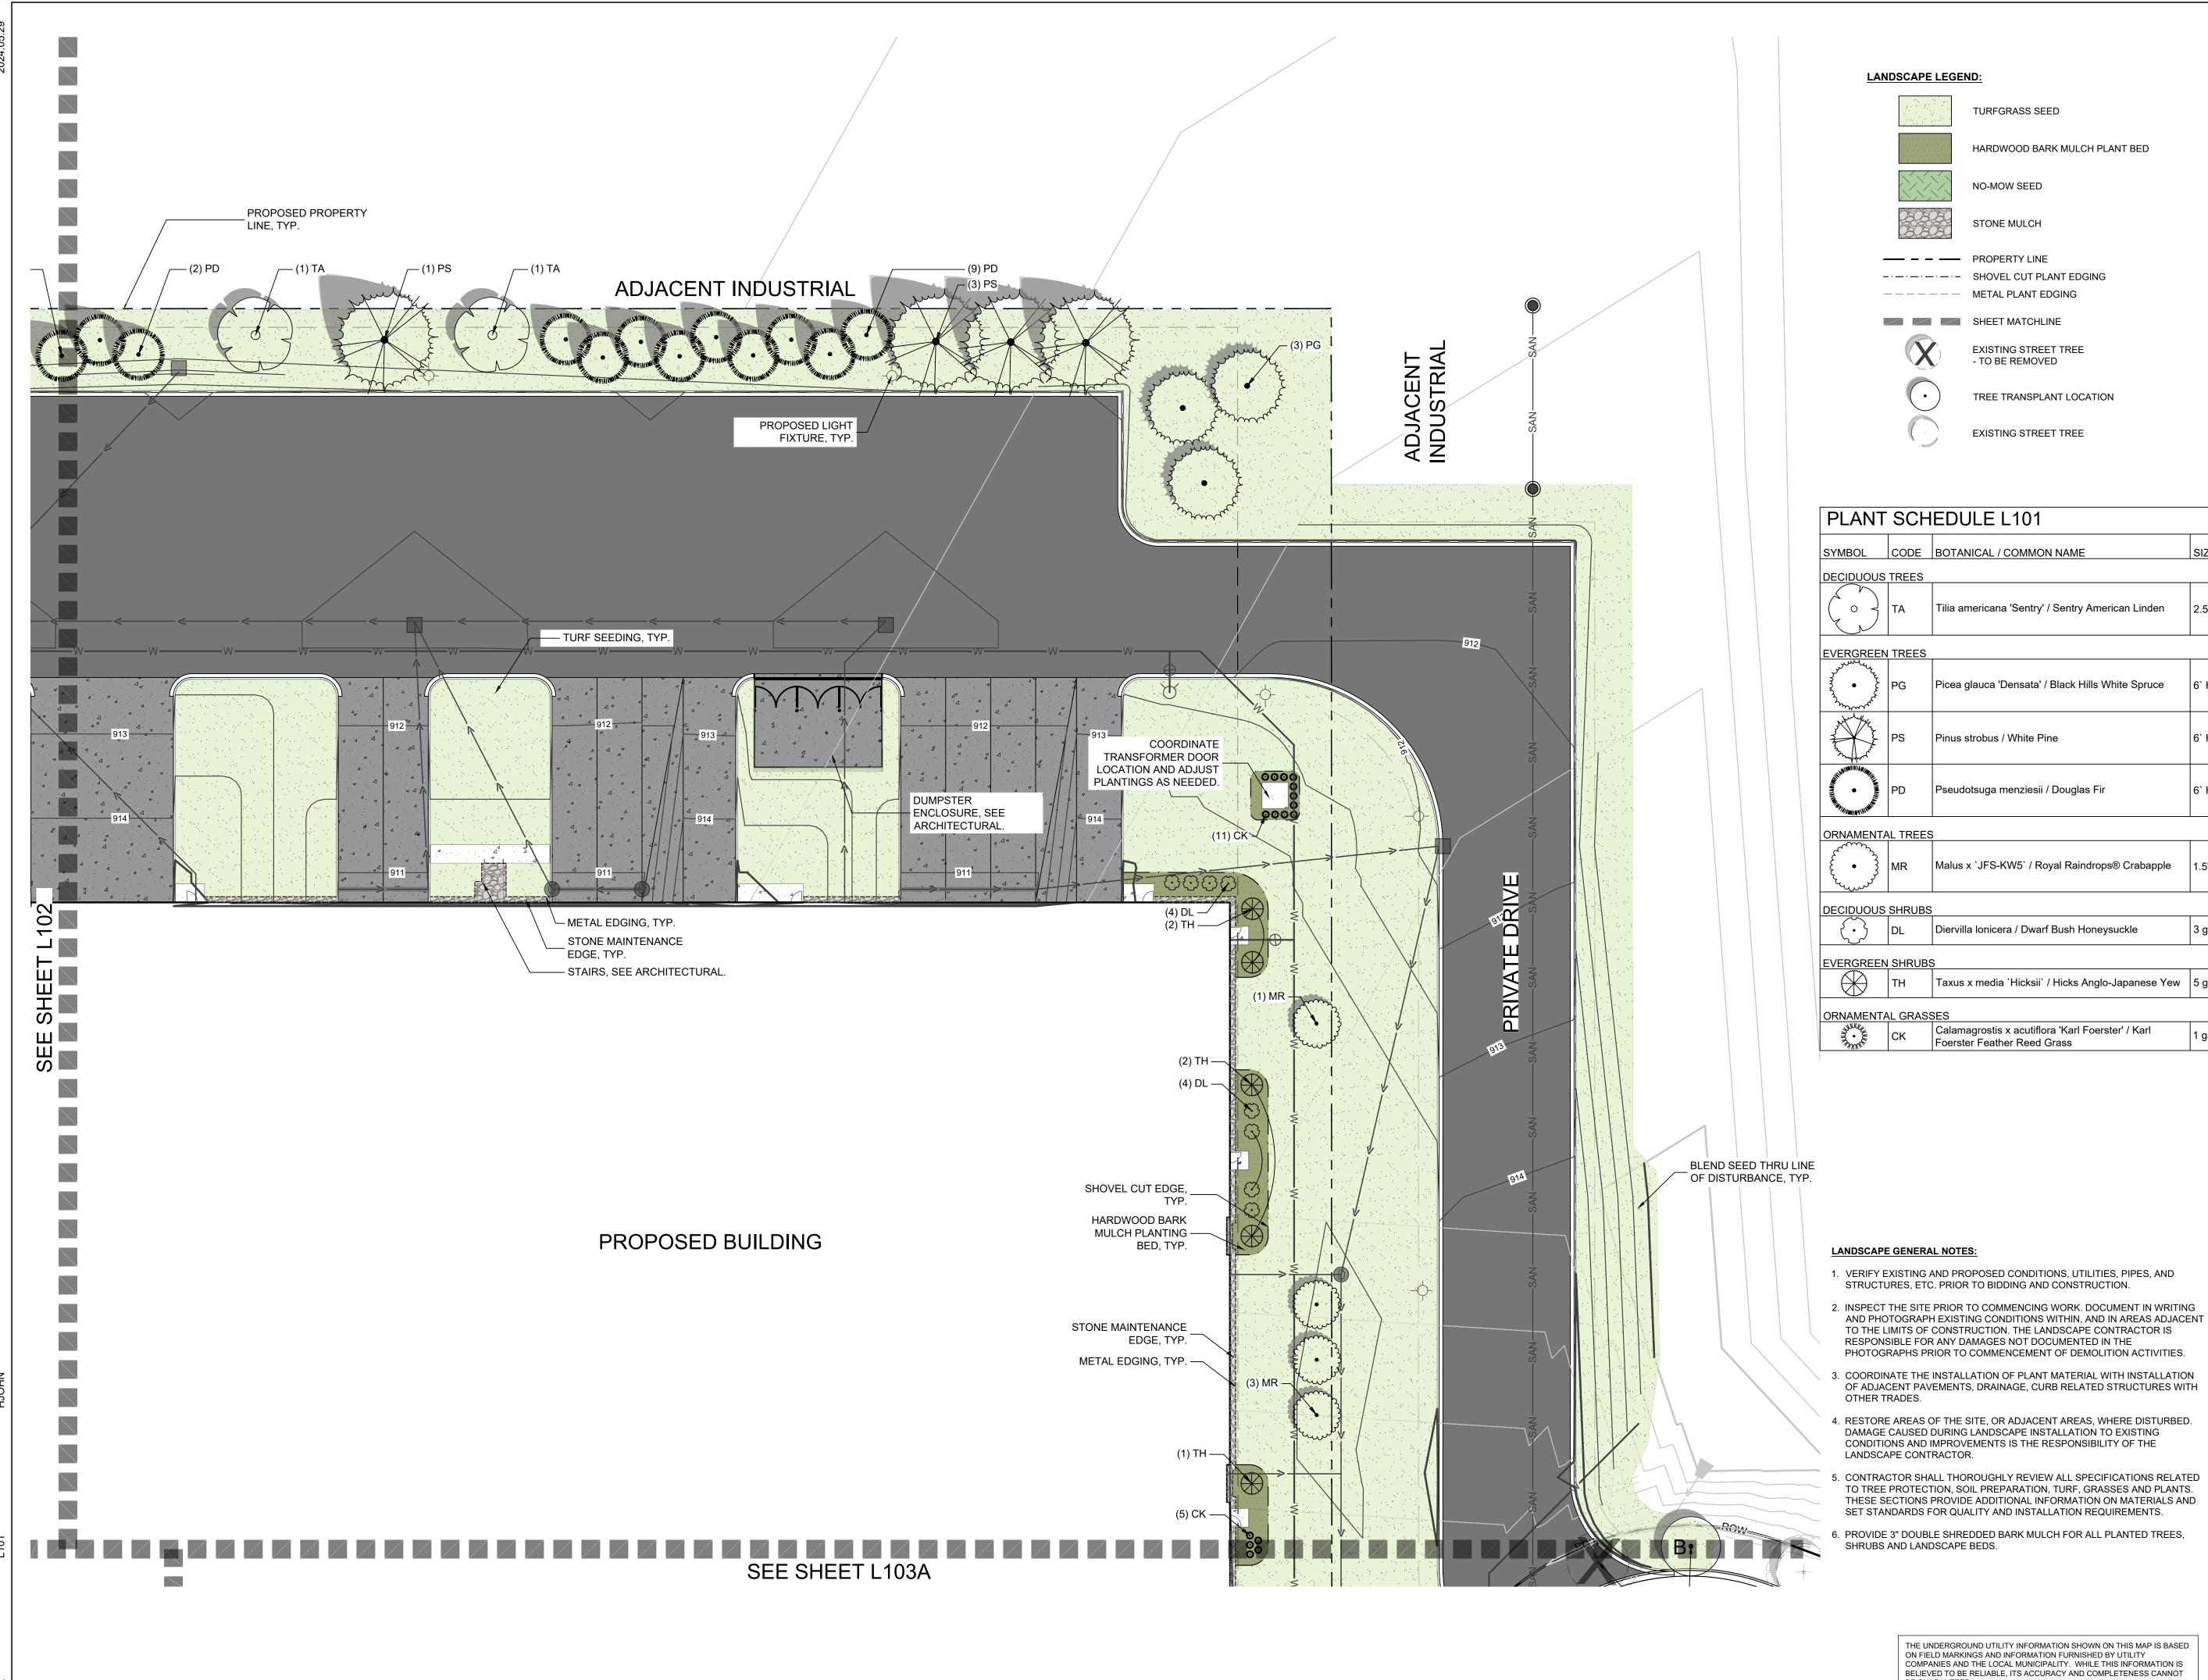
ISSUED FORMUNICIPAL REVIEW COMMENTS

MAY 10, 2024

SHEET BUILDING ELEVATIONS

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LANDSCAPE LEGEND:

TURFGRASS SEED

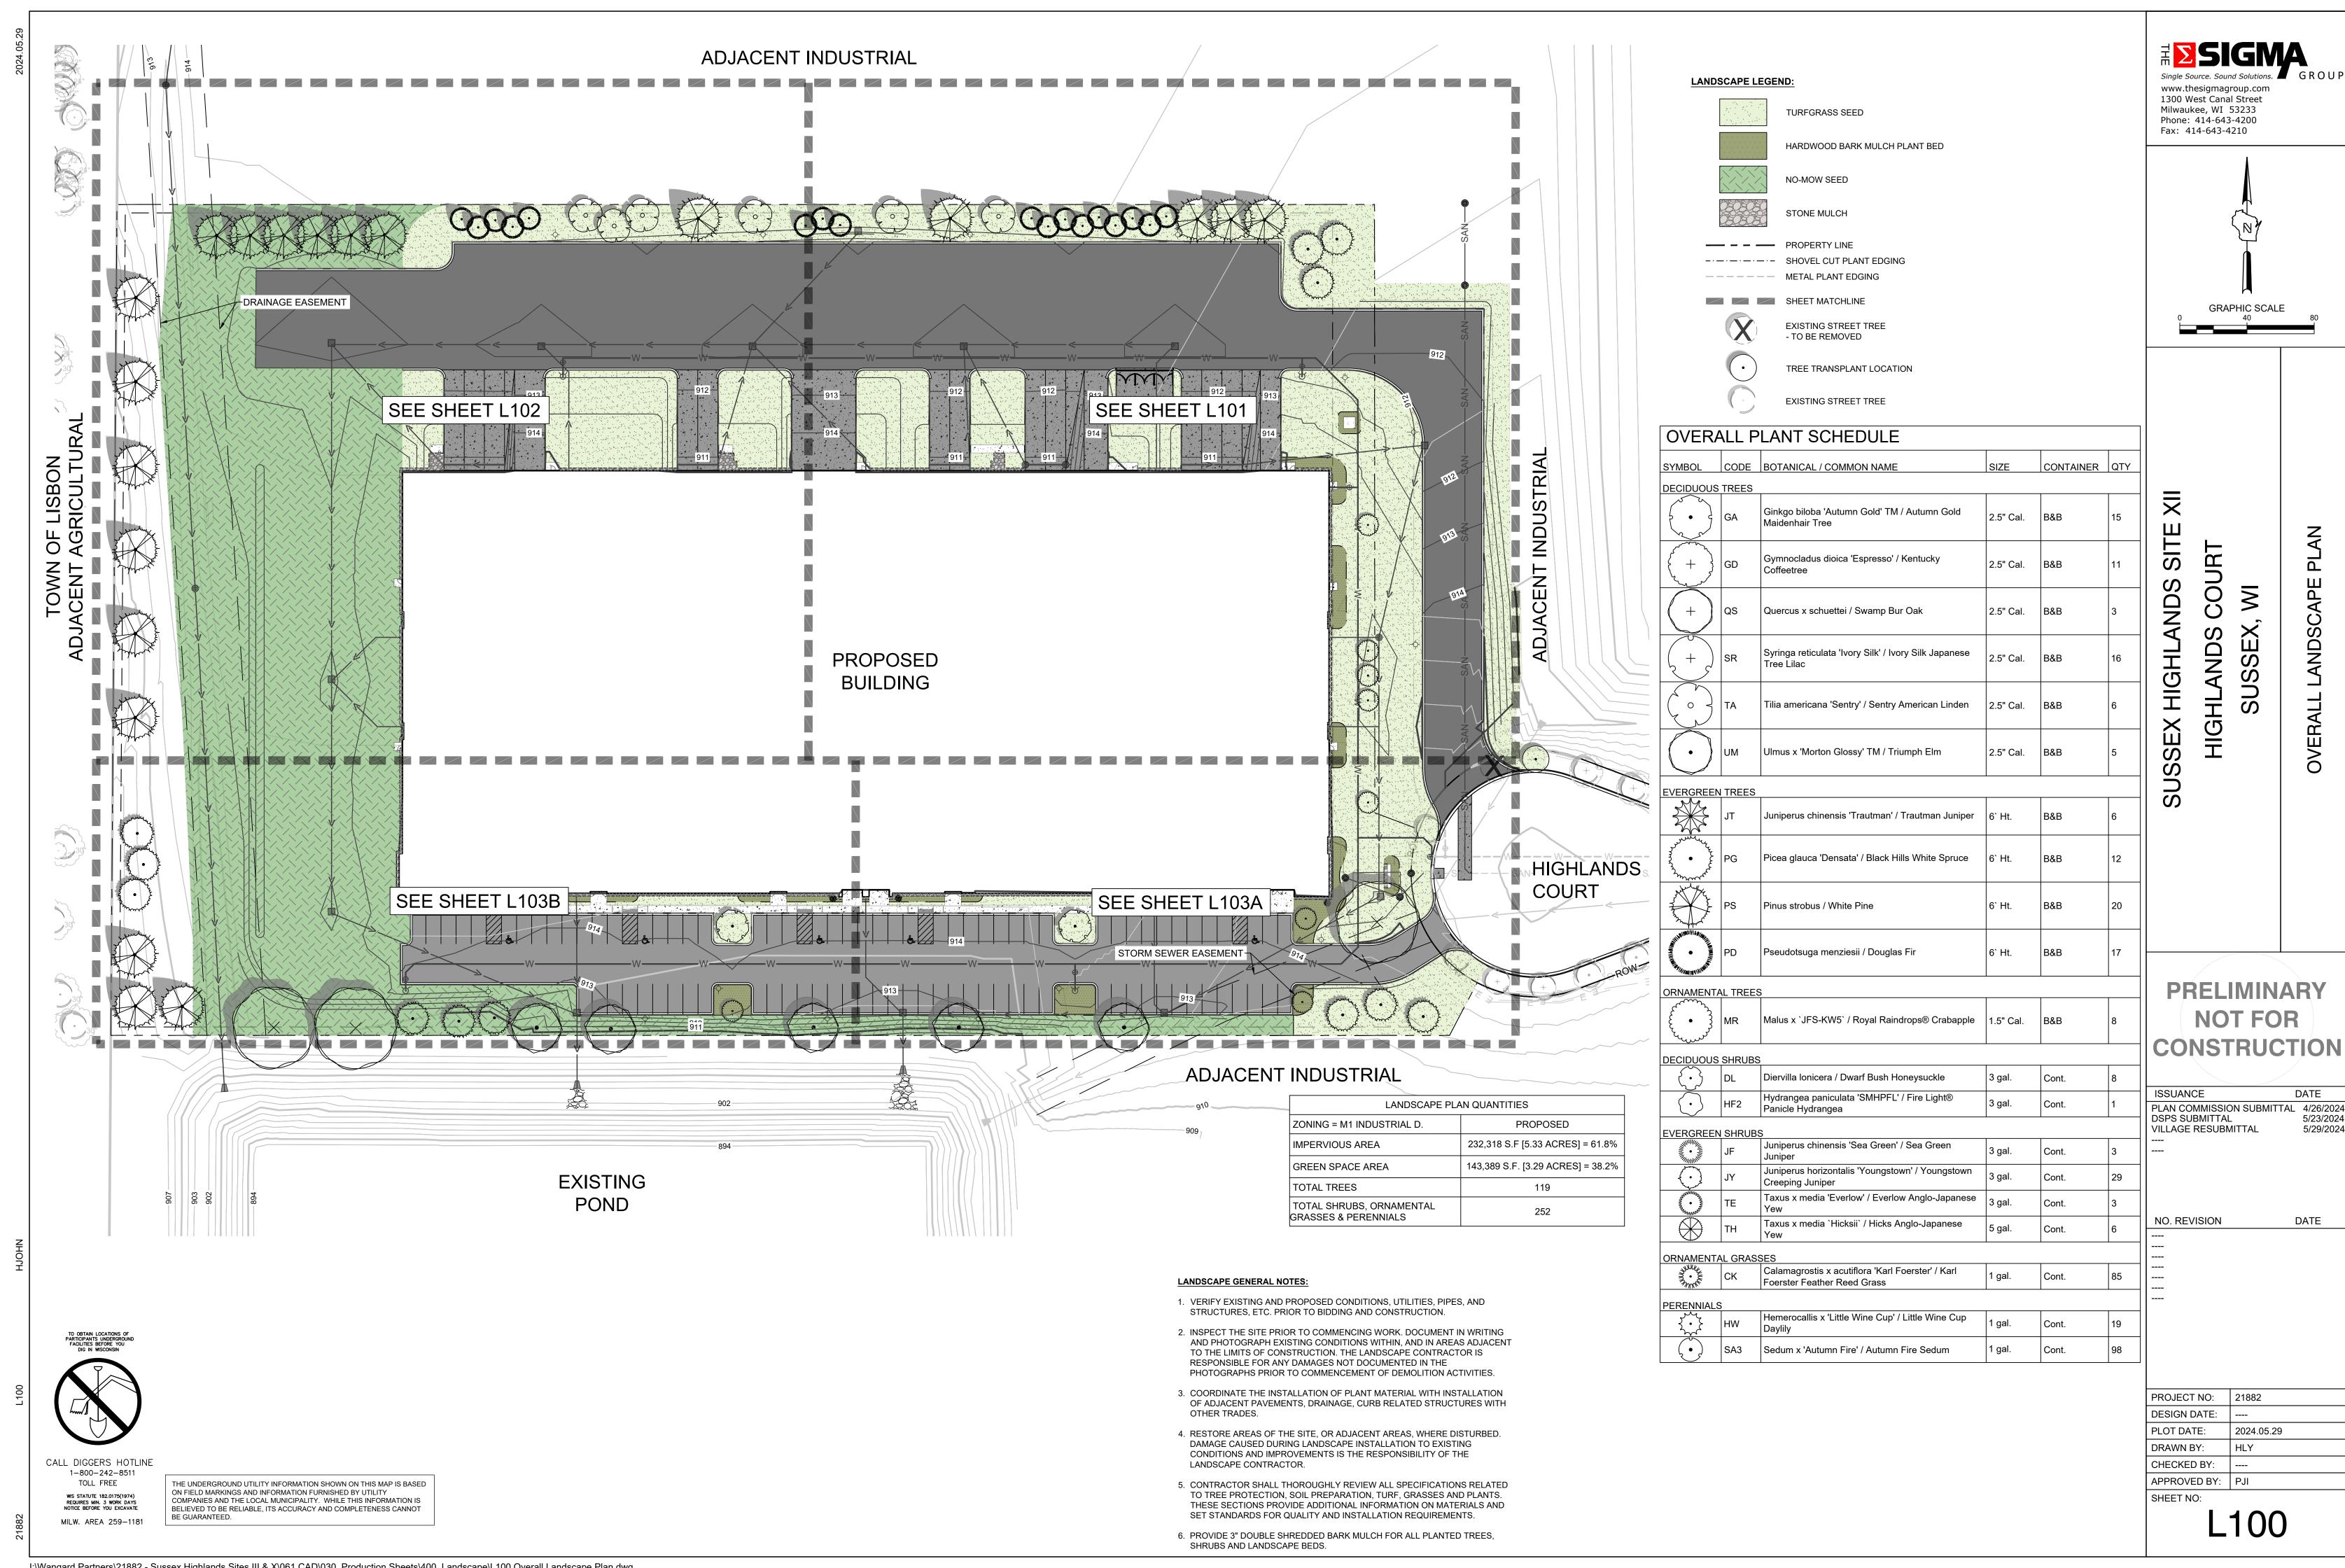HARDWOOD BARK MULCH PLANT BED

NO-MOW SEED

STONE MULCH

— – – PROPERTY LINE ————— METAL PLANT EDGING

SHEET MATCHLINE

EXISTING STREET TREE - TO BE REMOVED

TREE TRANSPLANT LOCATION

EXISTING STREET TREE

PLANT SCHEDULE L101

					1
SYMBOL	CODE	BOTANICAL / COMMON NAME	SIZE	CONTAINER	QTY
DECIDUOUS	TREES				
	ТА	Tilia americana 'Sentry' / Sentry American Linden	2.5" Cal.	B&B	2
EVERGREEN	N TREES				
33 • LE	PG	Picea glauca 'Densata' / Black Hills White Spruce	6` Ht.	B&B	3
The second secon	PS	Pinus strobus / White Pine	6` Ht.	B&B	4
MANUAL MA	PD	Pseudotsuga menziesii / Douglas Fir	6` Ht.	B&B	11
ORNAMENTA	AL TREES	5			
£ • 33	MR	Malus x `JFS-KW5` / Royal Raindrops® Crabapple	1.5" Cal.	B&B	4
DECIDUOUS	SHRUBS				
$\bigcirc$	DL	Diervilla Ionicera / Dwarf Bush Honeysuckle	3 gal.	Cont.	8
EVERGREEN	N SHRUB	S			
	ТН	Taxus x media `Hicksii` / Hicks Anglo-Japanese Yew	5 gal.	Cont.	5
ORNAMENTA	AL GRAS	SES			
99 · K	СК	Calamagrostis x acutiflora 'Karl Foerster' / Karl	1 gal.	Cont.	14

Foerster Feather Reed Grass

## **PRELIMINARY NOT FOR** CONSTRUCTION

**HLANDS** 

H

ENLARGEMENT

LANDSC/

www.thesigmagroup.com 1300 West Canal Street

Milwaukee, WI 53233 Phone: 414-643-4200 Fax: 414-643-4210

ISSUANCE DATE PLAN COMMISSION SUBMITTAL 4/26/2024 DSPS SUBMITTAL 5/23/2024 VILLAGE RESUBMITTAL 5/29/2024

NO. REVISION DATE

PROJECT NO: 21882

2024.05.29

HLY

L101

DESIGN DATE: PLOT DATE:

DRAWN BY:

SHEET NO:

CHECKED BY:


APPROVED BY: PJI

CALL DIGGERS HOTLINE 1-800-242-8511 TOLL FREE

WIS STATUTE 182.0175(1974) REQUIRES MIN. 3 WORK DAYS NOTICE BEFORE YOU EXCAVATE

MILW. AREA 259-1181

THE UNDERGROUND UTILITY INFORMATION SHOWN ON THIS MAP IS BASED ON FIELD MARKINGS AND INFORMATION FURNISHED BY UTILITY COMPANIES AND THE LOCAL MUNICIPALITY. WHILE THIS INFORMATION IS BELIEVED TO BE RELIABLE, ITS ACCURACY AND COMPLETENESS CANNOT BE GUARANTEED.

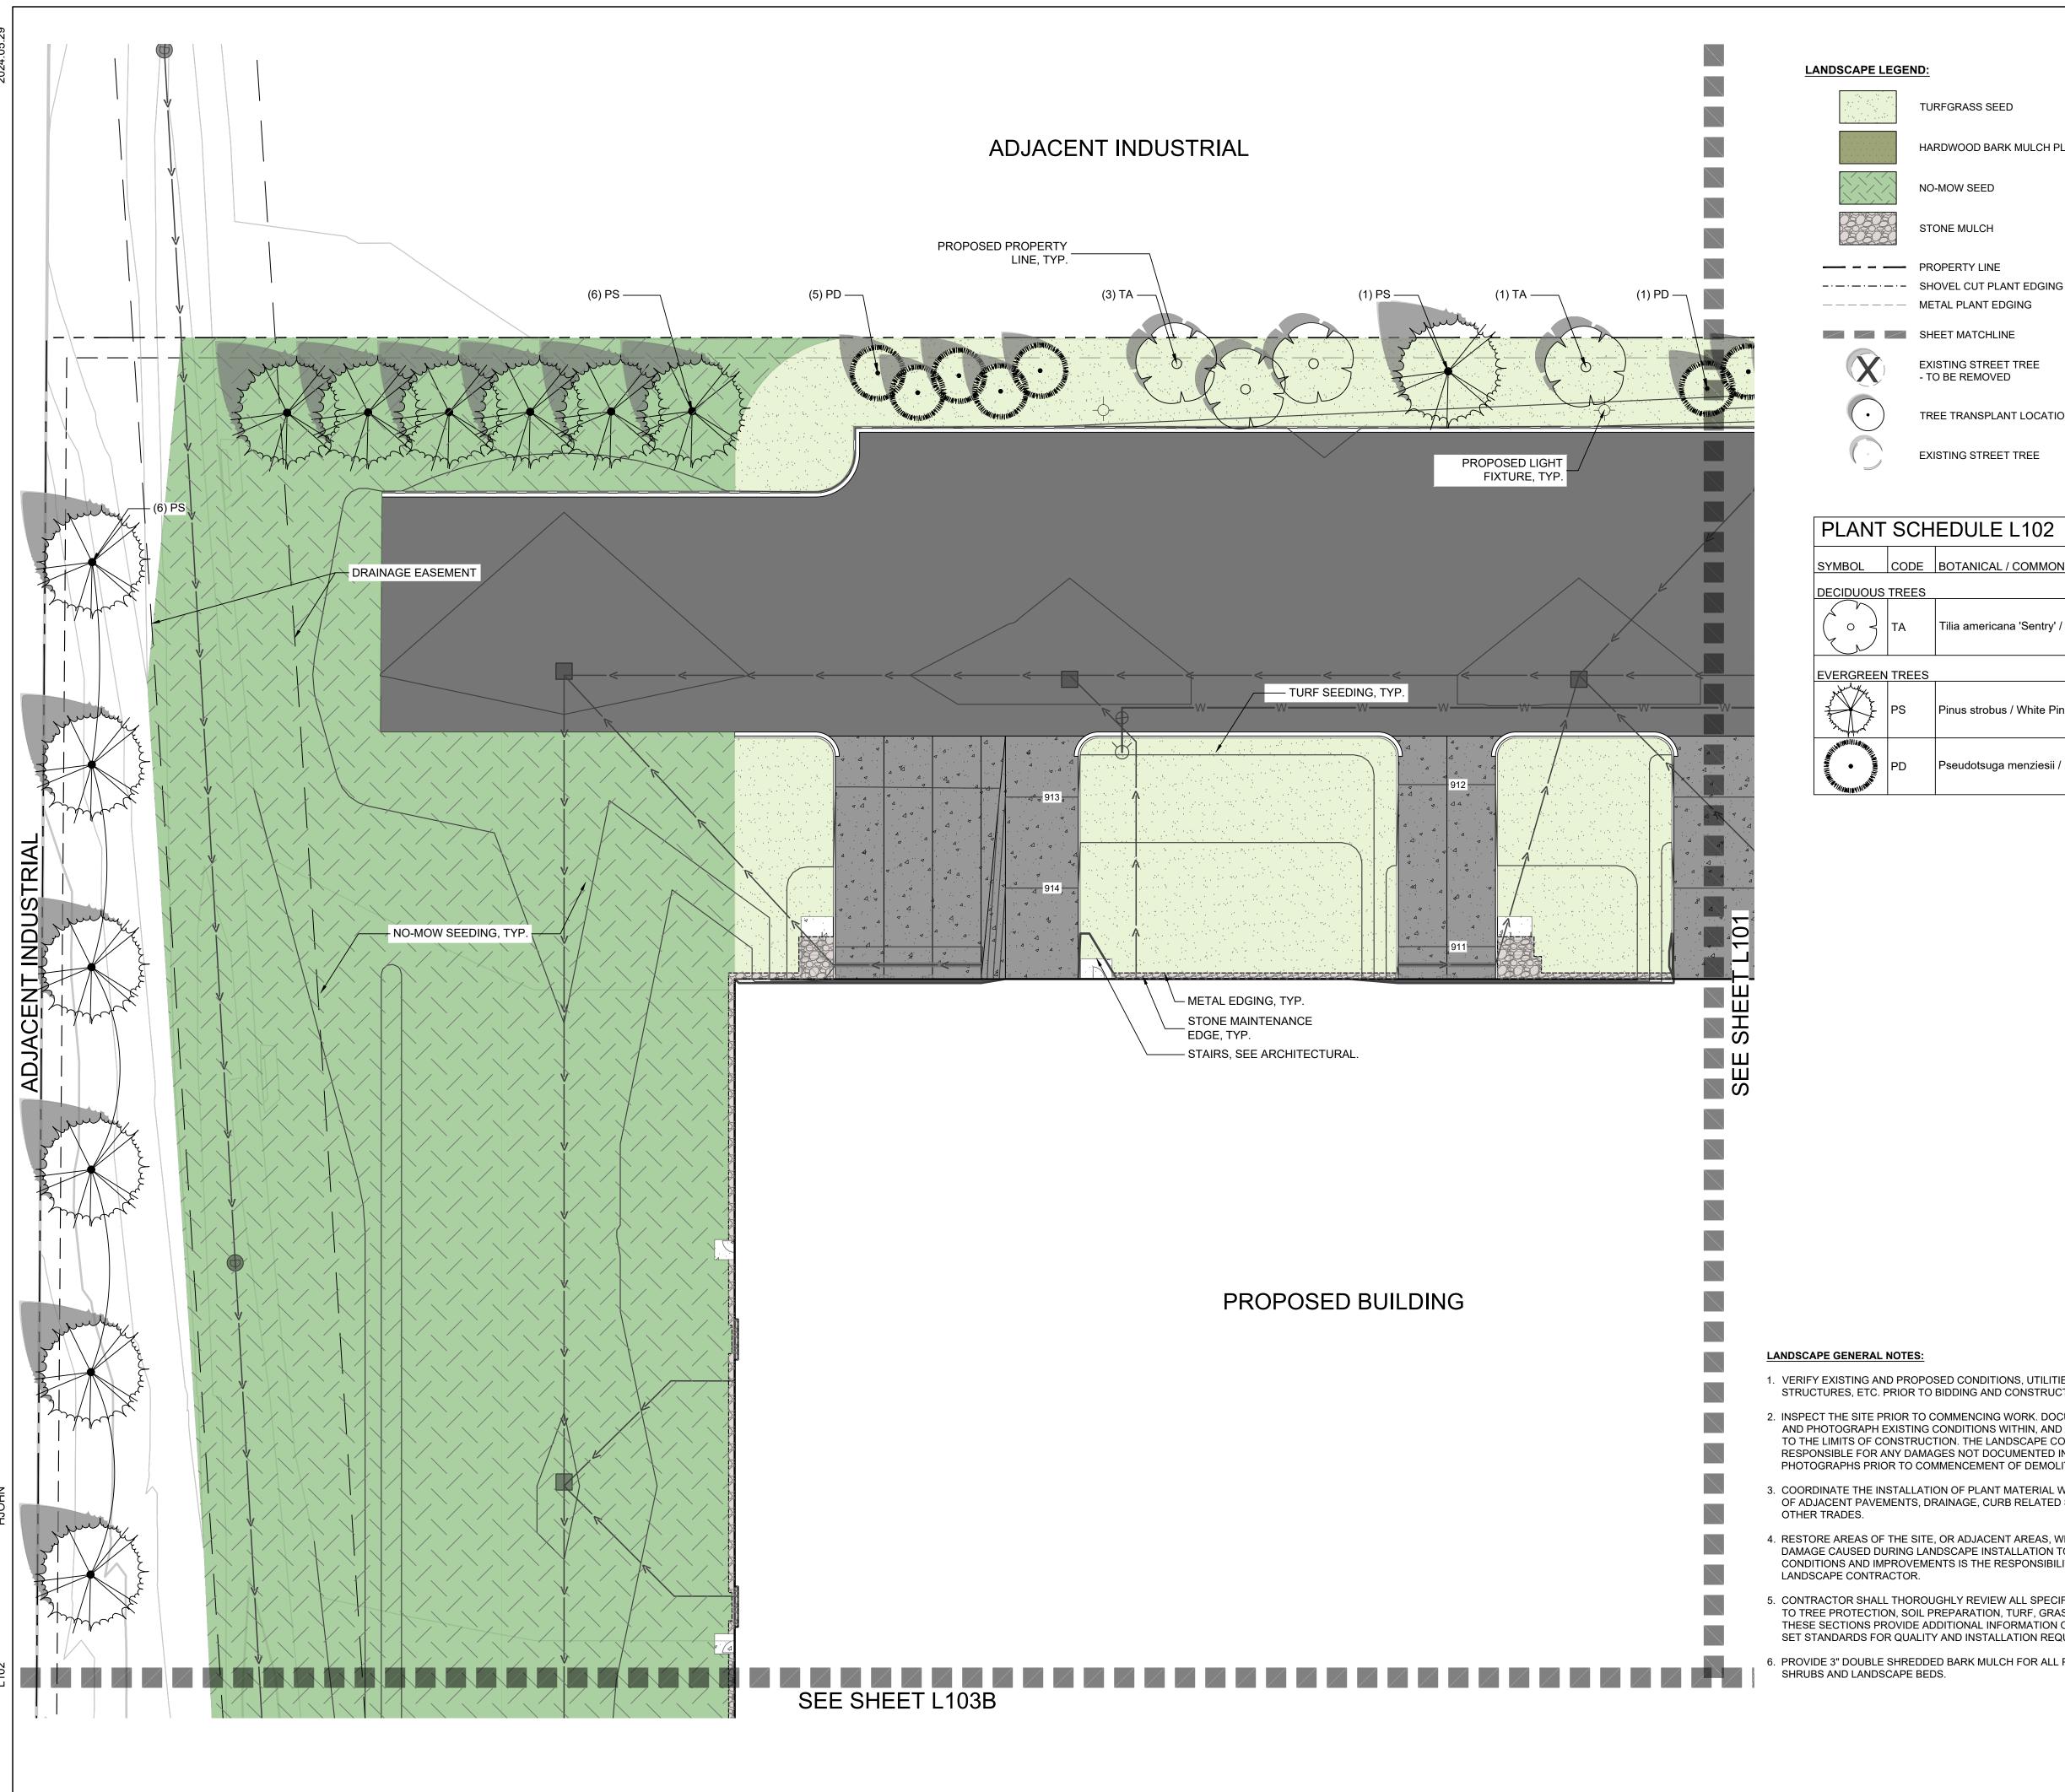






HARDWOOD BARK MULCH PLANT BED



NO-MOW SEED

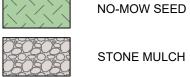

----- METAL PLANT EDGING

SHEET MATCHLINE



- TO BE REMOVED

TREE TRANSPLANT LOCATION



EXISTING STREET TREE

**EXISTING STREET TREE** 

PLANT SCHEDULE L102					
SYMBOL	CODE	BOTANICAL / COMMON NAME	SIZE	CONTAINER	QTY
DECIDUOUS	TREES				
	ТА	Tilia americana 'Sentry' / Sentry American Linden	2.5" Cal.	B&B	4
EVERGREEN	I TREES				
The state of the s	PS	Pinus strobus / White Pine	6` Ht.	B&B	13
WALLAND WALLEN TO THE PARTY OF	PD	Pseudotsuga menziesii / Douglas Fir	6` Ht.	B&B	6

## **LANDSCAPE GENERAL NOTES:**


- 1. VERIFY EXISTING AND PROPOSED CONDITIONS, UTILITIES, PIPES, AND STRUCTURES, ETC. PRIOR TO BIDDING AND CONSTRUCTION.
- 2. INSPECT THE SITE PRIOR TO COMMENCING WORK. DOCUMENT IN WRITING AND PHOTOGRAPH EXISTING CONDITIONS WITHIN, AND IN AREAS ADJACENT TO THE LIMITS OF CONSTRUCTION. THE LANDSCAPE CONTRACTOR IS RESPONSIBLE FOR ANY DAMAGES NOT DOCUMENTED IN THE PHOTOGRAPHS PRIOR TO COMMENCEMENT OF DEMOLITION ACTIVITIES.
- 3. COORDINATE THE INSTALLATION OF PLANT MATERIAL WITH INSTALLATION OF ADJACENT PAVEMENTS, DRAINAGE, CURB RELATED STRUCTURES WITH
- 4. RESTORE AREAS OF THE SITE, OR ADJACENT AREAS, WHERE DISTURBED. DAMAGE CAUSED DURING LANDSCAPE INSTALLATION TO EXISTING CONDITIONS AND IMPROVEMENTS IS THE RESPONSIBILITY OF THE
- 5. CONTRACTOR SHALL THOROUGHLY REVIEW ALL SPECIFICATIONS RELATED TO TREE PROTECTION, SOIL PREPARATION, TURF, GRASSES AND PLANTS. THESE SECTIONS PROVIDE ADDITIONAL INFORMATION ON MATERIALS AND SET STANDARDS FOR QUALITY AND INSTALLATION REQUIREMENTS.
- 6. PROVIDE 3" DOUBLE SHREDDED BARK MULCH FOR ALL PLANTED TREES, SHRUBS AND LANDSCAPE BEDS.

THE UNDERGROUND UTILITY INFORMATION SHOWN ON THIS MAP IS BASED ON FIELD MARKINGS AND INFORMATION FURNISHED BY UTILITY COMPANIES AND THE LOCAL MUNICIPALITY. WHILE THIS INFORMATION IS BELIEVED TO BE RELIABLE, ITS ACCURACY AND COMPLETENESS CANNOT BE GUARANTEED.



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HIGHLANDS

LANDSCAPE

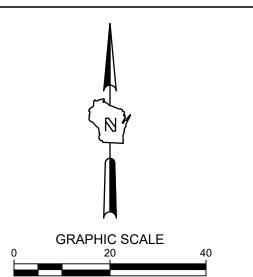
## **PRELIMINARY NOT FOR** CONSTRUCTION

ISSUANCE	DATE
PLAN COMMISSION SUBMITTAL DSPS SUBMITTAL VILLAGE RESUBMITTAL	4/26/2024 5/23/2024 5/29/2024
<del></del>	

NO. REVISION DATE

PROJECT NO: 21882 DESIGN DATE: PLOT DATE: 2024.05.29 DRAWN BY: HLY CHECKED BY: APPROVED BY: PJI

SHEET NO:

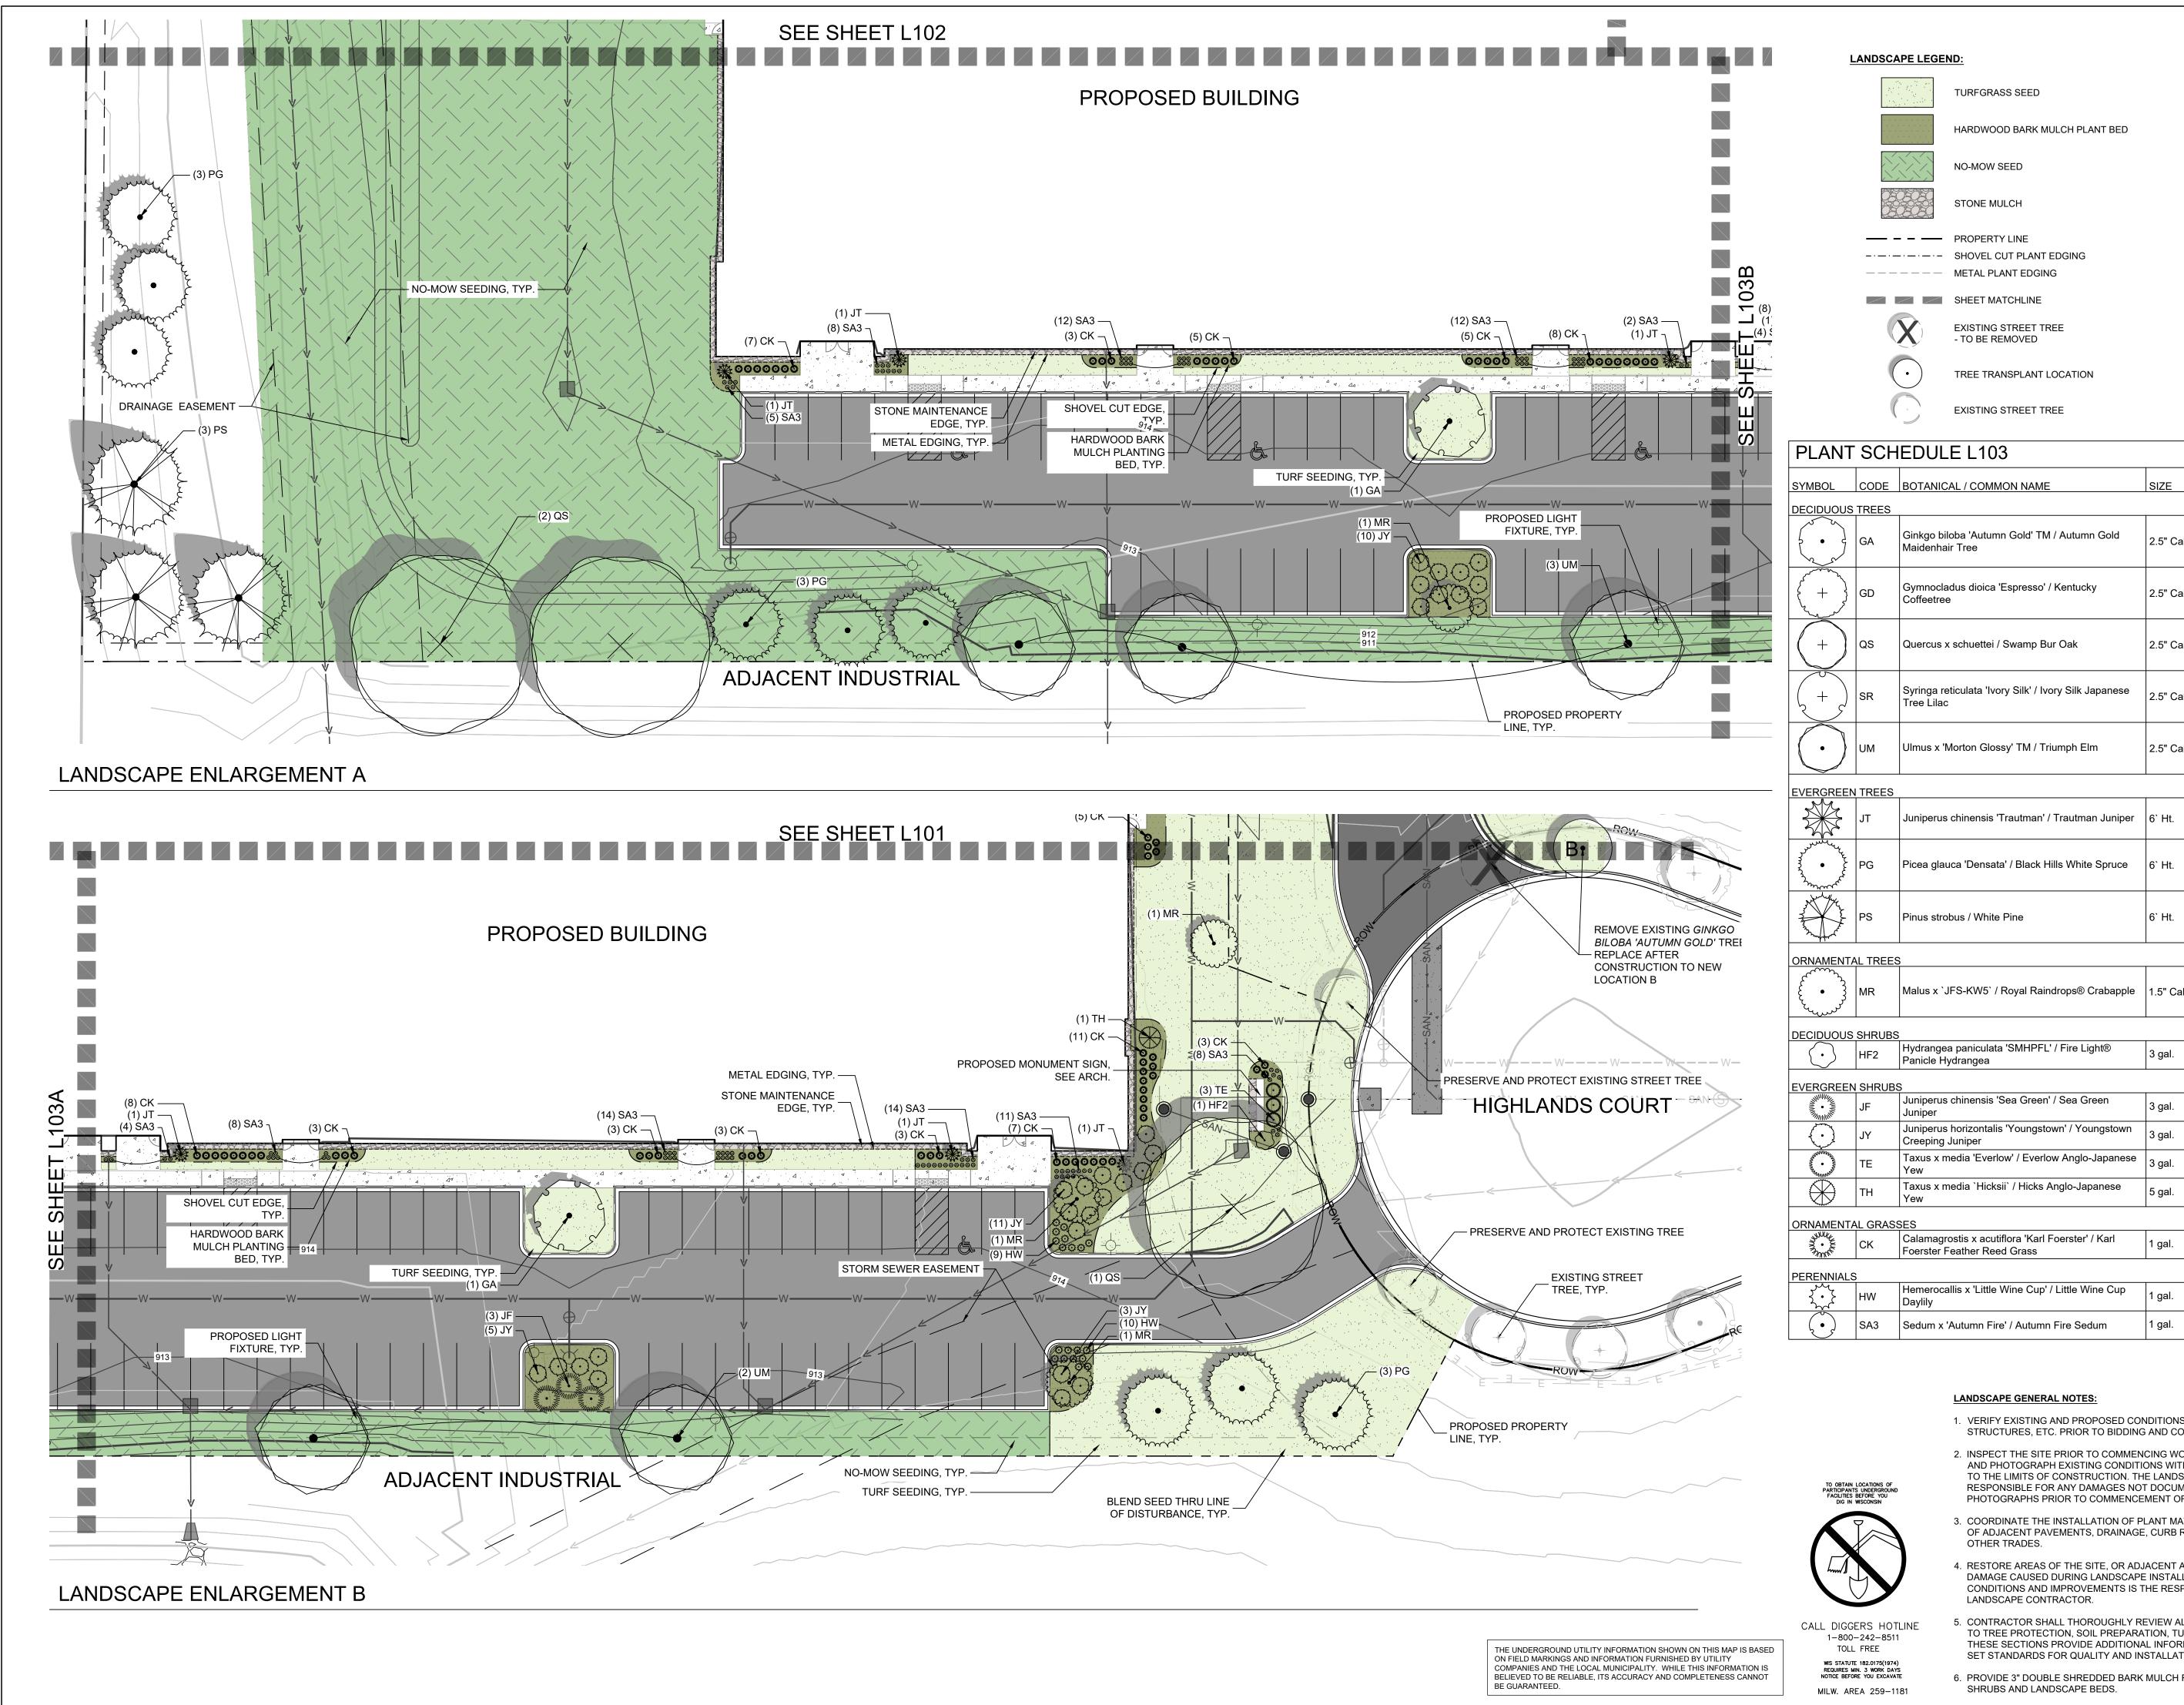

2.5" Cal.

2.5" Cal. 2.5" Cal. 2.5" Cal. 2.5" Cal.

-	EVERGREEN TREES					
		JT	Juniperus chinensis 'Trautman' / Trautman Juniper	6` Ht.	B&B	6
	22 0 K	PG	Picea glauca 'Densata' / Black Hills White Spruce	6` Ht.	B&B	9
	The second secon	PS	Pinus strobus / White Pine	6` Ht.	B&B	3
	ORNAMENTA	AL TREES				
	کرریی					


ORNAMENTA	L TREES	8			
£ • 33	MR	Malus x `JFS-KW5` / Royal Raindrops® Crabapple	1.5" Cal.	B&B	
DECIDUOUS	SHRUBS				
$\bigcirc$	HF2	Hydrangea paniculata 'SMHPFL' / Fire Light®	3 gal.	Cont.	

$\langle$		1 dillolo i lydidilgod			
/ERGREEN	SHRUBS				
	JF	Juniperus chinensis 'Sea Green' / Sea Green Juniper	3 gal.	Cont.	3
	JY	Juniperus horizontalis 'Youngstown' / Youngstown Creeping Juniper	3 gal.	Cont.	29
WANNIE OF THE PROPERTY OF THE	TE	Taxus x media 'Everlow' / Everlow Anglo-Japanese Yew	3 gal.	Cont.	3
$\bigoplus$	TH	Taxus x media `Hicksii` / Hicks Anglo-Japanese Yew	5 gal.	Cont.	1

L	Junyora .					1
	ORNAMENTA	L GRASS	BES			
	SOUNCE SANNER	СК	Calamagrostis x acutiflora 'Karl Foerster' / Karl Foerster Feather Reed Grass	1 gal.	Cont.	71
	PERENNIALS					
- 1			l <u>-</u>	I	I	

- 1. VERIFY EXISTING AND PROPOSED CONDITIONS, UTILITIES, PIPES, AND STRUCTURES, ETC. PRIOR TO BIDDING AND CONSTRUCTION.
- 2. INSPECT THE SITE PRIOR TO COMMENCING WORK. DOCUMENT IN WRITING AND PHOTOGRAPH EXISTING CONDITIONS WITHIN, AND IN AREAS ADJACENT TO THE LIMITS OF CONSTRUCTION. THE LANDSCAPE CONTRACTOR IS RESPONSIBLE FOR ANY DAMAGES NOT DOCUMENTED IN THE PHOTOGRAPHS PRIOR TO COMMENCEMENT OF DEMOLITION ACTIVITIES.
- 3. COORDINATE THE INSTALLATION OF PLANT MATERIAL WITH INSTALLATION OF ADJACENT PAVEMENTS, DRAINAGE, CURB RELATED STRUCTURES WITH
- 4. RESTORE AREAS OF THE SITE, OR ADJACENT AREAS, WHERE DISTURBED. DAMAGE CAUSED DURING LANDSCAPE INSTALLATION TO EXISTING CONDITIONS AND IMPROVEMENTS IS THE RESPONSIBILITY OF THE
- 5. CONTRACTOR SHALL THOROUGHLY REVIEW ALL SPECIFICATIONS RELATED TO TREE PROTECTION, SOIL PREPARATION, TURF, GRASSES AND PLANTS. THESE SECTIONS PROVIDE ADDITIONAL INFORMATION ON MATERIALS AND SET STANDARDS FOR QUALITY AND INSTALLATION REQUIREMENTS.
- 6. PROVIDE 3" DOUBLE SHREDDED BARK MULCH FOR ALL PLANTED TREES,

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**HLANDS** 

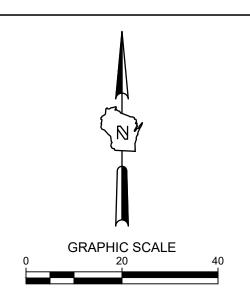CONTAINER QTY

## **PRELIMINARY NOT FOR** CONSTRUCTION

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PLAN COMMISSION SUBMITT DSPS SUBMITTAL VILLAGE RESUBMITTAL	AL 4/26/2024 5/23/2024 5/29/2024
_ <del></del>	
NO. REVISION	DATE

PROJECT NO: 21882 DESIGN DATE: PLOT DATE: 2024.05.29 DRAWN BY: CHECKED BY: APPROVED BY: | PJI

SHEET NO:

SHOVEL CUT PLANT EDGE


SCALE: N.T.S.

1. PLANT EACH TREE SUCH THAT THE ROOT FLARE IS VISIBLE AT THE TOP OF THE ROOT BALL. DO NOT COVER THE TOP OF THE ROOT BALL WITH SOIL.

2. DEPTH OF THE PLANTING HOLE SHOULD BE DETERMINED AND DUG AFTER THE ROOT FLARE IS LOCATED. PLANTING HOLE MUST BE NO DEEPER THAN THE HEIGHT OF THE ROOT BALL.

3. IF PLANT IS SHIPPED WITH A WIRE BASKET AROUND THE ROOT BALL, CUT AND REMOVE THE WIRE BASKET ENTIRELY. REMOVE ALL TWINE, ROPE, AND BURLAP COMPLETELY FROM ALL ROOT BALLS.

- 4. PLACE ROOT BALL ON UNEXCAVATED OR TAMPED SOIL.
- 5. DO NOT PLACE MULCH IN CONTACT WITH STEMS.
- 6. WATER ALL PLANTS WITHIN 2 HOURS OF INSTALLATION.
- 7. PRUNE ONLY AS NECESSARY TO REMOVE UNHEALTHY BRANCHES. DO NOT REMOVE MORE THAN 1/3 OF THE ORIGINAL PLANT MASS.

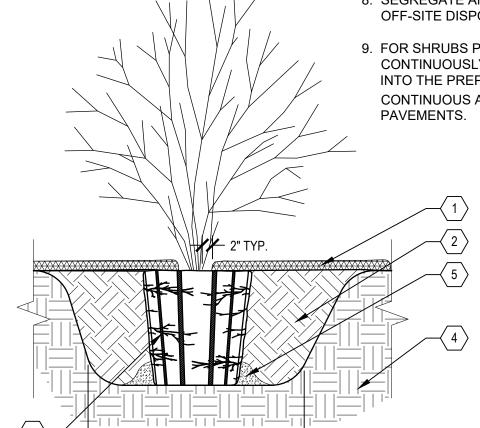

PLANTING PIT WIDTH - 2X BALL

DIAMETER MINIMUM, OR FULL

EXTENTS OF PLANTING BED

PROVIDE 4'-0" DIAMETER MULCH RINGS AT THE BASE OF ANY TREES PLANTED IN LAWN.

- ( 2 ) PROVIDE SPADED EDGE, 2" WIDE, 6" DEEP FOR ENTIRE PERIMETER OF BARK MULCH RINGS AT BASE OF TREES PLANTED IN LAWNS
- PLACED IN ONE CONTINUOUS VOLUME FOR THE ENTIRE AREA OF ANY GIVEN PLANT BED.
- 4 PREPARED SUBGRADE
- TAMP SOIL AROUND BALL BASE FIRMLY WITH FOOT PRESSURE SO THAT BALL DOES NOT SHIFT

NOTES:

- 1. MAKE 1" TO 2" DEEP VERTICAL CUTS EVERY 6" AROUND THE CIRCUMFERENCE OF THE ROOT BALL BEFORE PLANTING TO LOOSEN POT-BOUND ROOTS.
- 2. PLANT EACH SHRUB SUCH THAT THE ROOT FLARE IS VISIBLE AT THE TOP OF THE ROOT BALL. DO NOT COVER THE TOP OF THE ROOT BALL WITH SOIL.
- 3. PLANTING HOLE MUST NOT BE DEEPER THAN THE HEIGHT OF THE ROOT BALL.
- 4. DO NOT PLACE MULCH IN CONTACT WITH STEMS.
- 5. PLACE ROOT BALL ON UNEXCAVATED OR TAMPED SOIL.
- 6. WATER ALL PLANTS WITHIN 2 HOURS OF INSTALLATION.
- 7. PRUNE ONLY AS NECESSARY TO REMOVE UNHEALTHY BRANCHES. DO NOT REMOVE MORE THAN  $\frac{1}{3}$  OF THE ORIGINAL PLANT MASS.
- 8. SEGREGATE ANY SOIL FROM BELOW WARNING LAYER EXCAVATED DURING PLANTING FOR OFF-SITE DISPOSAL. COORDINATE DISPOSAL WITH ENVIRONMENTAL CONSULTANT.

9. FOR SHRUBS PLANTED WITHIN PLANTING BEDS, CONTRACTOR SHALL PROVIDE PLANTING SOIL CONTINUOUSLY FOR THE ENTIRE PLANTING BED AND INDIVIDUAL SHRUBS SHALL BE PLANTED INTO THE PREPARED PLANTING SOIL. MULCH SURFACE FOR PLANTING BEDS SHALL ALSO BE CONTINUOUS ACROSS THE ENTIRE SURFACE AND HELD  $\frac{1}{2}$ " MIN. TO 1" MAX. BELOW ADJACENT

1 3" DEPTH TWICE-SHREDDED HARDWOOD BARK MULCH,

UNLESS OTHERWISE INDICATED, KEEP 2" CLEAR OF

2 > PLANTING SOIL AS SPECIFIED, PLANTING SOIL SHALL BE

PLACED IN ONE CONTINUOUS VOLUME FOR

1" TO 2" DEEP VERTICAL CUTS EVERY 6"


AROUND PERIMETER

4 PREPARED SUBGRADE

THE ENTIRE AREA OF ANY GIVEN PLANT BED

 $\langle$  5  $\rangle$  TAMP SOIL AROUND BALL BASE FIRMLY WITH FOOT

PRESSURE SO THAT BALL DOES NOT SHIFT

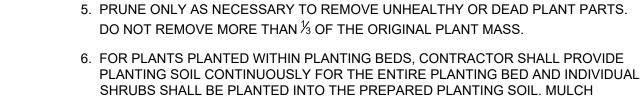

3. DO NOT PLACE MULCH IN CONTACT WITH STEMS.

1. DO NOT COVER THE TOP OF THE ROOT BALL WITH SOIL.

2. PLANTING HOLE MUST NOT BE DEEPER THAN THE HEIGHT OF THE ROOT BALL

SURFACE FOR PLANTING BEDS SHALL ALSO BE CONTINUOUS ACROSS THE

ENTIRE SURFACE AND HELD  $\frac{1}{2}$ " MIN. TO 1" MAX. BELOW ADJACENT PAVEMENTS.

4. WATER ALL PLANTS THOROUGHLY WITHIN 2 HOURS OF INSTALLATION.

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KEYED LEGEND

- 1 PERENNIAL, ORNAMENTAL GRASS, OR GROUNDCOVER PLUG, SEE LANDSCAPE PLAN SHEETS
- 3" DEPTH TWICE-SHREDDED HARDWOOD BARK MULCH, UNLESS OTHERWISE INDICATED, KEEP 3" CLEAR OF STEMS
- PLANTING SOIL, PLANTING SOIL SHALL BE PLACED IN ONE CONTINUOUS VOLUME FOR THE ENTIRE AREA OF ANY GIVEN PLANT BED
- 4 PREPARED SUBGRADE

 $\langle 1 \rangle$  3" DEPTH SHREDDED HARDWOOD BARK MULCH.

- 3 PLANTING SOIL, PLANTING SOIL SHALL BE

B TYPICAL SHRUB PLANTING SCALE: N.T.S.

TYPICAL PERENNIAL & ORNAMENTAL GRASS PLANTING SCALE: N.T.S.

 $\begin{pmatrix} 1 \end{pmatrix}$  3" DEPTH OF MULCH LAYER

(3) LAWN ADJACENT TO PLANTING BED

(4) 45 DEGREE ANGLE SHOVEL CUT EDGE TOWARD PLANTING

2 SHRUB PLANTING BED

5 COMPACTED SUBGRADE

1. SET FINISH GRADE OF PLANTING AREA 2" BELOW FINISH SURFACE OF PAVING, CURB, OR HEADER

2. SEE PLANTING SCHEDULE FOR SPACING OF ALL SHRUBS AND GROUNDCOVERS 3. ALL SHRUBS / GROUNDCOVER TO BE PLANTED AT

EQUAL SPACING (TRIANGULAR) UNLESS OTHERWISE INDICATED ON PLANS.

4. TO DETERMINE APPROPRIATE PLANT QUANTITIES REFER TO THE PLANTING SCHEDULE OR PLAN.

(1) EDGE OF ADJACENT PAVEMENT

2 SHRUB, PERENNIAL OR ORNAMENTAL GRASS PLANT CENTER LOCATION

→ 2% SLOPE, MIN.,

VARIES, PER PLAN

1 ADJACENT PLANTING BED

KEYED LEGEND

 $\langle$   $^2$   $\rangle$  BLACK ANODIZED ALUMINUM EDGING

(3) BUILDING FACE

 $\langle$  4  $\rangle$  3" DEPTH STONE MULCH

WOVEN GEOTEXTILE FILTER FABRIC, WRAP UP SIDES OF BUILDING AND EDGING

6 PREPARED SUBGRADE


STONE MAINTENANCE EDGE SCALE: N.T.S.

NOTES:

1. REMOVE BURLAP FROM TOP ROOT BALL, OR, WITH CONTAINER PLANTS, REMOVE POTS AND SEPARATE POT BOUND ROOTS AS SPECIFIED.

2. ONLY PRUNE BROKEN BRANCHES AFTER INSTALLATION 3.DO NOT TRIM MAIN LEADER BRANCH.

6" MIN. SHRUBS 12" MIN. FOR UP TO 3" CAL. TREES 18" MIN. FOR 3" CAL. & LARGER TREES

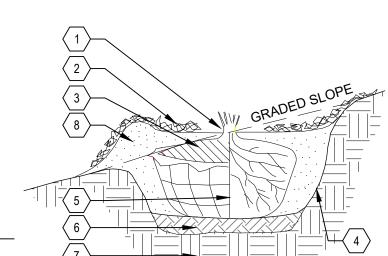

 $\left\langle 2 \right\rangle$  3" DEEP MULCH. DO NOT COVER ROOT FLARE BALLED AND BURLAPPED PLANT

PLANTING BACKFILL, SCARIFY SIDES OF PLANT PIT.

SET ROOT FLARE COLLAR AT SLOPE LINE


(5) BARE ROOT OR CONTAINER SHRUB

 $\langle$   $_{6}$   $\rangle$  SCARIFY TO 4" DEPTH AND RECOMPACT. DEPTH AS REQUIRED

7 > PREPARED SUBGRADE

ROUND TOPPED SOIL BERM 4" HIGH X 8" WIDE ABOVE ROOT BALL SURFACE AROUND THE TREE. BERM SHALL BE CENTERED ON DOWNHILL SIDE OF THE ROOTBALL FOR AT LEAST 245°.

TREE PLANTING ON SLOPE (H) SCALE: N.T.S.

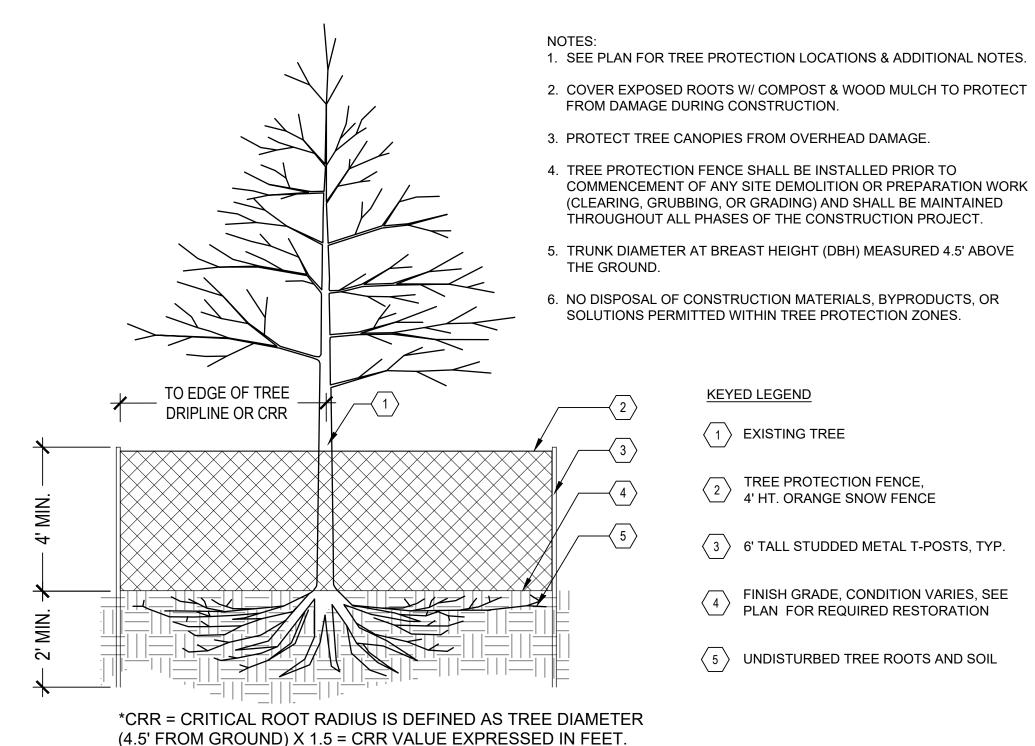

**KEYED LEGEND** 

1 EXISTING TREE

2 4' HT. ORANGE SNOW FENCE TREE PROTECTION FENCE,

 $\langle$  3  $\rangle$  6' TALL STUDDED METAL T-POSTS, TYP.

FINISH GRADE, CONDITION VARIES, SEE PLAN FOR REQUIRED RESTORATION

 $\langle$   $_{5}$   $\rangle$  UNDISTURBED TREE ROOTS AND SOIL

TREE PROTECTION FENCE Ĵ SCALE:N.T.S.

NO. REVISION DATE

**PRELIMINARY** 

**NOT FOR** 

CONSTRUCTION

PLAN COMMISSION SUBMITTAL 4/26/2024

DATE

5/23/2024

5/29/2024

ISSUANCE

DSPS SUBMITTAL

VILLAGE RESUBMITTAL

AND

HG

AND

PROJECT NO: 21882 DESIGN DATE: PLOT DATE: 2024.05.29 DRAWN BY: HLY CHECKED BY: APPROVED BY: | PJI SHEET NO:

L200

PLANTING QUALITY ASSURANCE

- 1. PLANTS ARE TO BE INSPECTED UPON DELIVERY TO PROJECT SITE AND THE LANDSCAPE ARCHITECT OR OWNER'S PROJECT REPRESENTATIVE MAY REJECT ANY SPECIMENS NO LONGER MEETING THE SPECIFIED STANDARDS OR THAT HAVE BEEN DAMAGED IN TRANSIT.
- 2. ALL PLANT MATERIAL SHALL BE TRUE TO SPECIES AND VARIETY/HYBRID/CULTIVAR SPECIFIED, AND NURSERY GROWN IN ACCORDANCE WITH GOOD HORTICULTURAL PRACTICES, AND UNDER CLIMATIC CONDITIONS SIMILAR TO THOSE OF THE SITE LOCATION. SPECIMENS NURSERY-DUG TO BE REPLANTED SHALL HAVE BEEN FRESHLY DUG AND PROPERLY PREPARED FOR PLANTING.
- SHALL BE TRAINED IN DEVELOPMENT AND APPEARANCE AS TO BE SUPERIOR IN FORM, COMPACTNESS AND SYMMETRY. TREES WITH MULTIPLE LEADERS, UNLESS SPECIFIED OTHERWISE, AND SHRUBS WITH DAMAGED OR CUT MAINSTEM(S), WILL BE REJECTED.
- 3.2. WITH A DAMAGED, CUT OR CROOKED LEADER, ABRASION OF BARK, SUNSCALD, FROST CRACK, DISFIGURING KNOTS, INSECTS (INCLUDING EGGS AND LARVAE) OR INSECT DAMAGE, CANKERS/CANKEROUS LESIONS OR FUNGAL MATS, MOLD, PREMATURELY-OPENED BUDS, OR CUTS OF LIMBS OVER 3/2" DIAMETER THAT ARE NOT COMPLETELY CALLUSED WILL BE REJECTED.
- 3.3. SHALL HAVE HEALTHY, WELL-DEVELOPED ROOT SYSTEMS, AND BE FREE FROM PHYSICAL DAMAGE OR OTHER HINDRANCES TO HEALTHY GROWTH.
- BALLED AND BURLAPPED PLANTS SHALL BE DUG WITH SOLID BALLS OF A DIAMETER NOT LESS THAN THAT RECOMMENDED BY THE AMERICAN STANDARDS FOR NURSERY STOCK, AND OF SUFFICIENT DEPTH TO INCLUDE BOTH FIBROUS AND FEEDING ROOTS. BALLS SHALL BE SECURELY WRAPPED WITH BURLAP, AND TIGHTLY BOUND WITH ROPE OR TWINE. NO PLANTS SHALL BE BOUND WITH ROPE OR WIRE IN SUCH A MANNER AS TO DAMAGE BARK OR BREAK BRANCHES. THE ROOT FLARE SHOULD BE WITHIN THE TOP 2" OF THE SOIL BALL. BALLED AND BURLAPPED PLANTS WILL NOT BE ACCEPTED IF THE BALL IS DRY, CRACKED, OR BROKEN BEFORE OR DURING PLANTING.
- 4. PLANTS SHALL CONFORM TO THE MEASUREMENTS SPECIFIED WITHIN THE PLANT SCHEDULE

## PLANTING PROJECT CONDITIONS:

- 1. VERIFY SERVICE AND UTILITY LOCATIONS, AND DIMENSIONS OF CONSTRUCTION CONTIGUOUS WITH NEW PLANTINGS BY FIELD MEASUREMENTS BEFORE PROCEEDING WITH PLANTING WORK.
- 2. INTERRUPTION OF EXISTING SERVICES OR UTILITIES; DO NOT INTERRUPT SERVICES OR UTILITIES UNLESS PERMITTED UNDER THE FOLLOWING CONDITIONS AND THEN ONLY AFTER ARRANGING TO PROVIDE TEMPORARY SERVICES OR UTILITIES ACCORDING TO REQUIREMENTS INDICATED:
- 2.1. NOTIFY OWNER'S PROJECT REPRESENTATIVE NO FEWER THAN TWO DAYS IN ADVANCE OF PROPOSED INTERRUPTION OF EACH SERVICE OR UTILITY.
- 2.2. DO NOT PROCEED WITH INTERRUPTION OF SERVICES OR UTILITIES WITHOUT REPRESENTATIVE'S WRITTEN PERMISSION.
- 3. PLANTING RESTRICTIONS: PLANTING SHALL OCCUR DURING THE FOLLOWING ACCEPTABLE INSTALLATION PERIODS:
- 3.1. DECIDUOUS TREES AND SHRUBS APRIL 15 TO OCTOBER 15.
- 3.2. NATIVE SEEDING AND TURFGRASS: APRIL 15 OCTOBER 15
- 4. WEATHER LIMITATIONS: PROCEED WITH PLANTING ONLY WHEN EXISTING AND FORECASTED WEATHER CONDITIONS PERMIT PLANTING TO BE PERFORMED WHEN BENEFICIAL AND OPTIMUM RESULTS MAY BE OBTAINED. APPLY PRODUCTS DURING FAVORABLE WEATHER CONDITIONS ACCORDING TO MANUFACTURER'S WRITTEN INSTRUCTIONS AND WARRANTY REQUIREMENTS.
- 5. CONTRACTOR SHALL PROTECT ALL EXISTING AND/OR NEWLY INSTALLED PLANTS, LAWNS, AND GRASS AREAS FROM DAMAGE AT ALL TIMES. DAMAGED PLANTS, LAWNS OR GRASS AREAS SHALL BE REPLACED OR TREATED AS REQUIRED TO CONFORM TO SPECIFICATIONS HEREIN FOR FRESH STOCK. WORK AREA SHALL BE KEPT CLEAN AND ORDERLY DURING THE INSTALLATION PERIOD. UNDER NO CONDITION SHALL DEBRIS FROM PLANTING ACTIVITIES RESULT IN A SAFETY HAZARD ON-SITE OR ADJACENT OFF-SITE PROPERTY. DAMAGE TO SITE IMPROVEMENTS OR ADJACENT LANDSCAPES INCURRED AS A RESULT OF PLANTING OR REPLACEMENT OPERATIONS SHALL BE REPAIRED BY THE CONTRACTOR THAT CAUSES THE DAMAGE AT NO COST TO THE OWNER.
- 6. EXAMINE AREAS TO RECEIVE PLANTS FOR COMPLIANCE WITH REQUIREMENTS AND CONDITIONS AFFECTING INSTALLATION AND PERFORMANCE. PROCEED WITH INSTALLATION ONLY AFTER UNSATISFACTORY CONDITIONS HAVE BEEN CORRECTED.
- 6.1. VERIFY THAT NO FOREIGN OR DELETERIOUS MATERIAL OR LIQUID SUCH AS PAINT, PAINT WASHOUT, CONCRETE SLURRY, CONCRETE LAYERS OR CHUNKS, CEMENT, PLASTER, OILS. GASOLINE, DIESEL FUEL, PAINT THINNER, TURPENTINE, TAR, ROOFING COMPOUND, OR ACID HAS BEEN DEPOSITED IN SOIL WITHIN PLANTING AREAS.
- 6.2. DO NOT MIX OR PLACE SOILS IN FROZEN, WET, OR MUDDY CONDITIONS.

## PLANTING DELIVERY, STORAGE, & HANDLING:

- BULK MATERIALS;
- 1.1. DO NOT DUMP OR STORE BULK MATERIALS NEAR STRUCTURES, UTILITIES, WALKWAYS AND PAVEMENTS, OR ON EXISTING TURF AREAS OR PLANTS.
- 2. DO NOT PRUNE TREES AND SHRUBS BEFORE DELIVERY, PROTECT BARK, BRANCHES, AND ROOT SYSTEMS FROM SUN SCALD, DRYING, WIND BURN, SWEATING, WHIPPING, AND OTHER HANDLING AND TYING DAMAGE. DO NOT BEND OR BIND-TIE TREES OR SHRUBS IN SUCH A MANNER AS TO DESTROY THEIR NATURAL SHAPE. PROVIDE PROTECTIVE COVERING OF PLANTS DURING SHIPPING AND DELIVERY. DO NOT DROP PLANTS DURING DELIVERY AND HANDLING.
- 3. HANDLE PLANTING STOCK BY ROOT BALL.
- 4. DELIVER PLANTS AFTER PREPARATIONS FOR PLANTING HAVE BEEN COMPLETED AND INSTALL IMMEDIATELY. IF PLANTING IS DELAYED MORE THAN SIX HOURS AFTER DELIVERY, SET PLANTS AND TREES IN SHADED LOCATION, PROTECT FROM WEATHER AND MECHANICAL DAMAGE, AND KEEP ROOTS MOIST.
- 4.1. SET BALLED STOCK ON GROUND AND COVER BALL WITH SOIL, PEAT MOSS, SAWDUST, OR OTHER ACCEPTABLE MATERIAL.
- 4.2. WATER ROOT SYSTEMS OF PLANTS STORED ON-SITE DEEPLY AND THOROUGHLY WITH A FINE-MIST SPRAY. WATER AS OFTEN AS NECESSARY TO MAINTAIN ROOT SYSTEMS IN A MOIST, BUT NOT OVERLY WET CONDITION.

## **EXCAVATION FOR TREES & SHRUBS**

- EXCAVATE CIRCULAR PLANTING PITS AS INDICATED IN DRAWINGS. TRIM PERIMETER OF BOTTOM LEAVING CENTER AREA OF BOTTOM RAISED SLIGHTLY TO SUPPORT ROOT BALL AND ASSIST IN DRAINAGE AWAY FROM CENTER. DO NOT FURTHER DISTURB BASE. ENSURE THAT ROOT BALL WILL SIT ON UNDISTURBED BASE SOIL TO PREVENT SETTLING. SCARIFY SIDES OF PLANTING PIT SMEARED OR SMOOTHED DURING EXCAVATION.
- 1.1. EXCAVATE APPROXIMATELY THREE TIMES AS WIDE AS BALL DIAMETER FOR BALLED AND BURLAPPED STOCK.
- 1.2. DO NOT EXCAVATE DEEPER THAN DEPTH OF THE ROOT BALL, MEASURED FROM THE ROOT
- FLARE TO THE BOTTOM OF THE ROOT BALL IF AREA UNDER THE PLANT WAS INITIALLY DUG TOO DEEP, ADD SOIL TO RAISE IT TO CORRECT LEVEL AND THOROUGHLY TAMP THE ADDED SOIL TO PREVENT SETTLING.
- MAINTAIN REQUIRED ANGELS OF REPOSE OF ADJACENT MATERIALS AS SHOWN IN DRAWINGS. DO NOT EXCAVATE SUBGRADES OF ADJACENT PAVING, STRUCTURES, HARDSCAPES, OR OTHER NEW OR EXISTING IMPROVEMENTS.
- MAINTAIN SUPERVISION OF EXCAVATIONS DURING WORKING HOURS.
- KEEP EXCAVATIONS COVERED OR OTHERWISE PROTECTED WHEN UNATTENDED BY INSTALLER'S PERSONNEL
- 2. SUBSOIL AND TOPSOIL REMOVED FROM EXCAVATIONS MAY BE USED AS PLANTING SOIL IF THEY CONFORM TO THE REQUIREMENTS LISTED IN THESE SPECIFICATIONS.
- 3. NOTIFY OWNER'S PROJECT REPRESENTATIVE IF UNEXPECTED ROCK OR OBSTRUCTIONS DETRIMENTAL TO TREES OR SHRUBS ARE ENCOUNTERED IN EXCAVATIONS.
- 4. NOTIFY OWNER'S PROJECT REPRESENTATIVE IF SUBSOIL CONDITIONS EVIDENCE UNEXPECTED WATER SEEPAGE OR RETENTION IN TREE OR SHRUB PLANTING PITS.

## TREE & SHRUB PLANTING

- 1. BEFORE PLANTING VERIFY THAT ROOT FLARE IS VISIBLE AT TOP OF ROOT BALL. IF ROOT FLARE IS NOT VISIBLE, REMOVE SOIL IN A LEVEL MANNER FROM THE ROOT BALL TO WHERE THE TOP-MOST ROOT EMERGES FROM THE TRUNK. AFTER SOIL REMOVAL TO EXPOSE ROOT FLARE, VERIFY THAT ROOT BALL STILL MEETS SIZE REQUIREMENTS. PLANT MATERIAL WITHOUT ROOT FLARE VISIBLE OR PLANTED TOO LOW WILL BE RE-PLANTED AT THE REQUEST OF THE LANDSCAPE ARCHITECT AT NO ADDITIONAL COST TO THE OWNER.
- 2. PLANTS FOUND TO HAVE STEM GIRDLING ROOTS AND/OR KINKED ROOTS AT THE TIME OF PLANTING WILL BE REJECTED AND REPLACEMENTS SHALL BE PROVIDED AT NO ADDITIONAL COST
- 3. REMOVE ALL TWINE, STRING, WIRE, AND ALL OTHER NON-BIODEGRADABLE MATERIAL ENTIRELY FROM ROOT BALL AREA.
- 4. REMOVE ONLY DEAD, DYING, OR BROKEN BRANCHES. DO NOT PRUNE FOR SHAPE. DO CUT TREE LEADERS.
- 5. SET BALLED AND BURLAPPED STOCK PLUMB AND IN CENTER OF PLANTING PIT OR TRENCH WITH
- ROOT FLARE 2 INCHES ABOVE ADJACENT FINISH GRADES. 5.1. USE SOIL MATERIALS FROM EXCAVATION FOR BACKFILL

KNOTS, SUN SCALD, INJURIES, ABRASIONS, AND DISFIGUREMENT.

- CAREFULLY CUT AND REMOVE BURLAP, ROPE, AND WIRE BASKETS FROM THE ENTIRE ROOT BALL. REMOVE PALLETS, IF ANY, BEFORE SETTING. DO NOT USE PLANTING STOCK IF ROOT BALL IS CRACKED OR BROKEN BEFORE OR DURING PLANTING OPERATION.
- 5.3. BACKFILL AROUND ROOT BALL IN LAYERS, TAMPING TO SETTLE SOIL AND ELIMINATE VOIDS AND AIR POCKETS. WHEN PLANTING PIT IS APPROXIMATELY ONE-HALF FILLED, WATER THOROUGHLY BEFORE PLACING REMAINDER OF BACKFILL. REPEAT WATERING UNTIL NO MORE WATER IS ABSORBED.
- 5.4. CONTINUE BACKFILLING PROCESS. WATER AGAIN AFTER PLACING AND TAMPING FINAL LAYER OF SOIL.

## TREE & SHRUB MATERIAL:

- 1. GENERAL: FURNISH NURSERY-GROWN PLANTS TRUE TO GENUS, SPECIES, VARIETY, CULTIVAR, STEM FORM, SHEARING, AND OTHER FEATURES INDICATED IN PLANT SCHEDULE SHOWN AND DRAWINGS.; AND WITH HEALTHY ROOT SYSTEMS DEVELOPED BY TRANSPLANTING OR ROOT PRUNING. PROVIDE WELL-SHAPED, FULLY BRANCHED, HEALTHY, VIGOROUS STOCK, DENSELY FOLIATED WHEN IN LEAF AND FREE OF DISEASE, PESTS, EGGS, LARVAE, AND DEFECTS SUCH AS
- 1.1. TREES WITH DAMAGED. CROOKED. OR MULTIPLE LEADERS: TIGHT VERTICAL BRANCHES WHERE BARK IS SQUEEZED BETWEEN TWO BRANCHES OR BETWEEN BRANCH AND TRUNK ("INCLUDED BARK"); CROSSING TRUNKS; CUT-OFF LIMBS MORE THAN \( \frac{3}{4} \) IN DIAMETER; OR WITH STEM GIRDLING ROOTS WILL BE REJECTED.
- 1.2. COLLECTED STOCK: DO NOT USE PLANTS HARVESTED FROM THE WILD, FROM NATIVE STANDS, FROM AN ESTABLISHED LANDSCAPE PLANTING, OR NOT GROWN IN A STATE CERTIFIED
- 1.3. PLANT MATERIAL SHALL BE PROVIDED IN THE CONTAINER TYPE INDICATED IN THE DRAWINGS (B&B, CONTAINER, BARE ROOT, ETC.), UNLESS THE CONTRACTOR RECEIVES WRITTEN APPROVAL FROM THE LANDSCAPE ARCHITECT THAT SUBSTITUTION OF CONTAINER TYPE IS
- 2. FURNISH TREES WITH ROOT BALLS MEASURED FROM TOP OF ROOT BALL. ROOT FLARE SHALL BE VISIBLE BEFORE PLANTING.
- 3. SELECT STOCK FOR UNIFORM HEIGHT AND SPREAD.

## PLANTING SOIL:

PLANTING SOIL SHALL BE PLACED IN ONE CONTINUOUS VOLUME FOR THE WIDTH OF LANDSCAPE AREAS, AND A MINIMUM OF 3X THE DIAMETER OF THE ROOT BALL LENGTHWISE INSTALL PLANTING SOIL FOR PLANT BEDS IN 6" LIFTS, MINIMUM 8" DEPTH.

- 2. DO NOT APPLY PLANTING SOIL TO SATURATED OR FROZEN SUBGRADES.
- 3. PLANTING SOIL SHALL BE A MIX OF 6-PARTS TOPSOIL, 1-PART COMPOST (APPROVED FOR USE ON THE PROJECT). THOROUGHLY BLEND PLANTING SOIL OFF-SITE BEFORE SPREADING.
- 3.1. THE PROJECT WILL ACCEPT ONLY CLEAN, SALVAGED OR IMPORTED TOPSOIL CAPABLE OF PASSING THE 1" SIEVE, FREE OF ROCKS, DEBRIS, AND OF NOXIOUS WEEDS.
- STRIPPED, SALVAGED, OR MINED TOPSOIL MUST BE TAKEN FROM THE TOP 6-INCHES OF THE A-HORIZON, HAVING A DARK BROWN TO BLACK COLOR WITH A GRANULAR STRUCTURE AND CLAY CONTENT OF LESS THAN 25%, VERIFIED WITH A RIBBON TEST THAT YIELDS NO MORE THAN 1-INCH.

## METAL EDGING

- 1. STANDARD PROFILE, COMMERCIAL-GRADE, EXTRUDED ALUMINUM EDGING, FABRICATED IN STANDARD LENGTHS WITH INTERLOCKING SECTIONS WITH LOOPS STAMPED FROM FACE OF SECTIONS TO RECEIVE STAKES.
- 1.1. BASIS OF DESIGN: CLEANLINE BY PERMALOC OR APPROVED EQUAL.
- EDGING SIZE: 3/16-INCH-WIDE BY 5.5 INCHES DEEP 1.3. STAKES: ALUMINUM, ASTM 221, ALLOY 6061-T6, 18-INCHES LONG.
- 1.4. FINISH: BLACK DURAFLEX
- MANUFACTURERS: SUBJECT TO COMPLIANCE WITH REQUIREMENTS, AVAILABLE MANUFACTURERS OFFERING PRODUCTS THAT MAY BE INCORPORATED INTO THE WORK INCLUDE BUT ARE NOT LIMITED TO THE FOLLOWING: CURV-RITE, INC., PERMALOC CORPORATION, RUSSELL, J.D. COMPANY (THE), SURE-LOC EDGING CORPORATION
- INSTALL METAL EDGE IN ACCORDANCE WITH MANUFACTURER'S WRITTEN INSTRUCTIONS.
- ENSURE THAT METAL EDGING IS PROPERLY INSTALLED AND SECURED BEFORE INSTALLING STONE

## STONE MULCH MATERIAL & INSTALLATION:

- 1. SHALL BE HARD, DURABLE, STONE, WASHED FREE OF LOAM, SAND, CLAY, AND OTHER FOREIGN SUBSTANCES, OF THE FOLLOWING TYPE, SIZE RANGE, AND COLOR:
- 1.1. MATERIAL: ANGULAR WASHED STONE.
- SIZE: 1-1/2" DIAMETER
- 1.3. DEPTH: 3" MINIMUM DEPTH PLACED IN ONE LIFT 1.4. COLOR RANGE: BLEND OF DARK GREY & BLUE TONES
- 1.5. BASIS OF DESIGN: 1-1/2" 'AMERICAN HERITAGE' AGGREGATE BY COUNTY MATERIALS.
- 2. LIGHTLY COMPACT AREAS TO RECEIVE STONE MULCH
- 3. INSTALL WEED BARRIER FABRIC IN ACCORDANCE WITH MANUFACTURER'S WRITTEN INSTRUCTIONS; COMPLETELY COVER AREA TO BE MULCHED, OVERLAPPING EDGES OF FABRIC LENGTHS A MINIMUM OF 6-INCHES AND SECURING SEAMS WITH GALVANIZED PINS. WEED BARRIER FABRIC SHALL BE WRAPPED VERTICALLY UP THE OUTSIDE EDGES OF SURROUNDING CONCRETE FLATWORK OR CURB AND SECURED IN PLACE. HOLD FABRIC 2" CLEAR OF TOP OF ADJACENT CURB AND CONCRETE FLATWORK SO IT IS NOT VISIBLE FROM SURFACE.
- 4. PLACE AND FINISH STONE MULCH AS INDICATED IN DRAWINGS, ENSURING A SMOOTH, LEVEL TOP SURFACE FOR ALL STONE MULCH AREAS HELD APPROXIMATELY 1/2" BELOW THE TOP SURFACE OF ADJACENT PAVED AREAS OR METAL EDGING.

## **BARK MULCH MATERIAL & INSTALLATION**

- 1. TWICE-SHREDDED HARDWOOD BARK MULCH TO BE PROVIDED AS TOP-DRESSING FOR ALL AT-GRADE PLANTING BEDS IN LOCATIONS INDICATED ON PLANTING PLANS.
- 1.1. SIZE RANGE: MAXIMUM 2.5" TO 3"
- 1.2. COLOR: NATURAL, UN-DYED
- 1.3. PROVIDE 3" DEPTH MULCH FOR ALL PLANTING BEDS INDICATED AS BARK MULCH PLANTING BED.
- 2. KEEP BARK MULCH 2" CLEAR OF ALL STEMS OF PLANT MATERIAL

## TURF SEEDING:

- 1.1. DELIVER PACKAGED SEED MATERIALS IN ORIGINAL, UNOPENED CONTAINERS LABELED AS TO NAME AND ADDRESS OF SUPPLIER; SPECIFIC BLEND OF SEED; AND INDICATION OF CONFORMANCE WITH STATE AND FEDERAL LAWS, AS APPLICABLE.
- 2. PROJECT CONDITIONS:
- 2.1. SEED DURING ONE OF THE FOLLOWING PERIODS.
- 2.1.1. SPRING SEEDING SEASON: APRIL 1 TO JUNE 15. 2.1.2. FALL SEEDING SEASON: AUGUST 15 TO OCTOBER 1.
- PRODUCTS
- 3.0.1. PROVIDE THE FOLLOWING FOR TURFGRASS SEED BASIS OF DESIGN: REINDEERS DELUXE 50 SEED MIX OR APPROVED EQUAL
- TURFGRASS SEED MIX TO BE FERTILIZED WITH 'SCOTT'S STARTER FERTILIZER' BY THE 'SCOTTS
- MIRACLE-GRO COMPANY' OR APPROVED EQUAL
- 4. PROCEED WITH INSTALLATION ONLY AFTER UNSATISFACTORY CONDITIONS HAVE BEEN MET 5. REMOVE ANY AND ALL UNDESIRABLE VEGETATION THAT HAS GERMINATED IN THE AREAS TO BE SEEDED OR
- SODDED. CONTRACTOR SHALL EVALUATE THE USE OF A BROAD SPECTRUM, NON-PERSISTENT GLYSOPHATE-BASED HERBICIDE BASED ON SITE CONDITIONS.
- 5.1. DO NOT APPLY SEED UNTIL FIVE TO SEVEN DAYS AFTER LAST HERBICIDE TREATMENT. 6. FINISH GRADING: GRADE AREAS TO A SMOOTH, UNIFORM SURFACE PLANE WITH LOOSE, UNIFORMLY FINE

TEXTURE. GRADE TO WITHIN PLUS OR MINUS 1/2 INCH OF FINISH ELEVATION. ROLL AND RAKE, REMOVE RIDGES,

- AND FILL DEPRESSIONS TO MEET FINISH GRADES. LIMIT FINISH GRADING TO AREAS THAT CAN BE IMMEDIATELY SEEDED AND STABILIZED WITH EROSION CONTROL MATERIAL MOISTEN PREPARED AREA BEFORE SEEDING IF SOIL IS DRY. WATER THOROUGHLY AND ALLOW SURFACE
- DRY BEFORE SEEDING OR SODDING. DO NOT CREATE MUDDY SOIL. NO SEEDING SHALL OCCUR ON FROZEN GROUND OR AT TEMPERATURES LOWER THAN 32 DEGREES
- FARENHEIT OR IN THE FOLLOWING 5 DAYS AFTER PLANNED SEEDING OR SODDING. 9. SEEDING RATES TO BE PERFORMED IN ACCORDANCE WITH SEED SUPPLIER RECOMMENDATIONS.
- NO-MOW MIX SEEDING:
- 1.1. DELIVER PACKAGED SEED MATERIALS IN ORIGINAL, UNOPENED CONTAINERS LABELED AS TO NAME AND ADDRESS OF SUPPLIER; SPECIFIC BLEND OF SEED; AND INDICATION OF CONFORMANCE WITH STATE
- 2. PROJECT CONDITIONS: 2.1. SEED DURING ONE OF THE FOLLOWING PERIODS.

AND FEDERAL LAWS, AS APPLICABLE.

- 2.1.1. SPRING SEEDING SEASON: APRIL 1 TO JUNE 15.
- 2.1.2. FALL SEEDING SEASON: AUGUST 15 TO OCTOBER 1. PRODUCTS
- 3.0.1. PROVIDE THE FOLLOWING FOR NO-MOW SEED MIX BASIS OF DESIGN: REINDERS NO MOW/LOW
- GROW MIX OR APPROVED EQUAL NO-MOW SEED MIX TO BE FERTILIZED WITH 'SCOTT'S STARTER FERTILIZER' BY THE 'SCOTTS
- MIRACLE-GRO COMPANY' OR APPROVED EQUAL 4. PROCEED WITH INSTALLATION ONLY AFTER UNSATISFACTORY CONDITIONS HAVE BEEN MET
- 5. REMOVE ANY AND ALL UNDESIRABLE VEGETATION THAT HAS GERMINATED IN THE AREAS TO BE SEEDED. CONTRACTOR SHALL EVALUATE THE USE OF A BROAD SPECTRUM, NON-PERSISTENT GLYSOPHATE-BASED HERBICIDE BASED ON SITE CONDITIONS.
- 5.1. DO NOT APPLY SEED UNTIL FIVE TO SEVEN DAYS AFTER LAST HERBICIDE TREATMENT.
- 6. FINISH GRADING: GRADE AREAS TO A SMOOTH, UNIFORM SURFACE PLANE WITH LOOSE, UNIFORMLY FINE TEXTURE. GRADE TO WITHIN PLUS OR MINUS 1/2 INCH OF FINISH ELEVATION. ROLL AND RAKE, REMOVE RIDGES. AND FILL DEPRESSIONS TO MEET FINISH GRADES. LIMIT FINISH GRADING TO AREAS THAT CAN BE
- IMMEDIATELY SEEDED AND STABILIZED WITH EROSION CONTROL MATERIAL 7. MOISTEN PREPARED AREA BEFORE SEEDING IF SOIL IS DRY. WATER THOROUGHLY AND ALLOW SURFACE
- DRY BEFORE SEEDING. DO NOT CREATE MUDDY SOIL. 8. NO SEEDING SHALL OCCUR ON FROZEN GROUND OR AT TEMPERATURES LOWER THAN 32 DEGREES
- FAHRENHEIT OR IN THE FOLLOWING 5 DAYS AFTER PLANNED SEEDING OR SODDING. 9. SEEDING RATES TO BE PERFORMED IN ACCORDANCE WITH SEED SUPPLIER RECOMMENDATIONS.
- 10. IRRIGATE DURING THE ESTABLISHMENT PERIOD FOR 10 DAYS, AFTER THE ESTABLISHMENT PERIOD NO FERTILIZER OR IRRIGATION IS REQUIRED.
- 11. MOW TO A HEIGHT OF 4-INCHES OCCASIONALLY, IF UN-MOWED GRASS WILL GROW TO APPROXIMATELY 12-INCHES AND BEND OVER.

## CLEAN-UP AND PROTECTION

- 1. DURING PLANTING, KEEP ADJACENT PAVING AND CONSTRUCTION CLEAN AND WORK AREA IN AN ORDERLY CONDITION.
- 2. PROTECT PLANTS FROM DAMAGE DUE TO LANDSCAPE OPERATIONS AND OPERATIONS OF OTHER CONTRACTORS AND TRADES. MAINTAIN PROTECTION DURING INSTALLATION. TREAT. REPAIR. OR REPLACE DAMAGED PLANTINGS.
- AFTER INSTALLATION REMOVE ALL NURSERY TAGS, NURSERY STAKES, TIE TAPE, LABELS, WIRE, STRING, AND OTHER DEBRIS FROM PLANT MATERIAL, PLANTING AREAS, AND PROJECT SITE.


www.thesigmagroup.com 1300 West Canal Street Milwaukee, WI 53233 Phone: 414-643-4200 Fax: 414-643-4210

DATE


ISSUANCE

PROJECT NO: 21882 DESIGN DATE: PLOT DATE: 2024.05.29 DRAWN BY: HLY CHECKED BY: APPROVED BY: | PJI

SHEET NO:

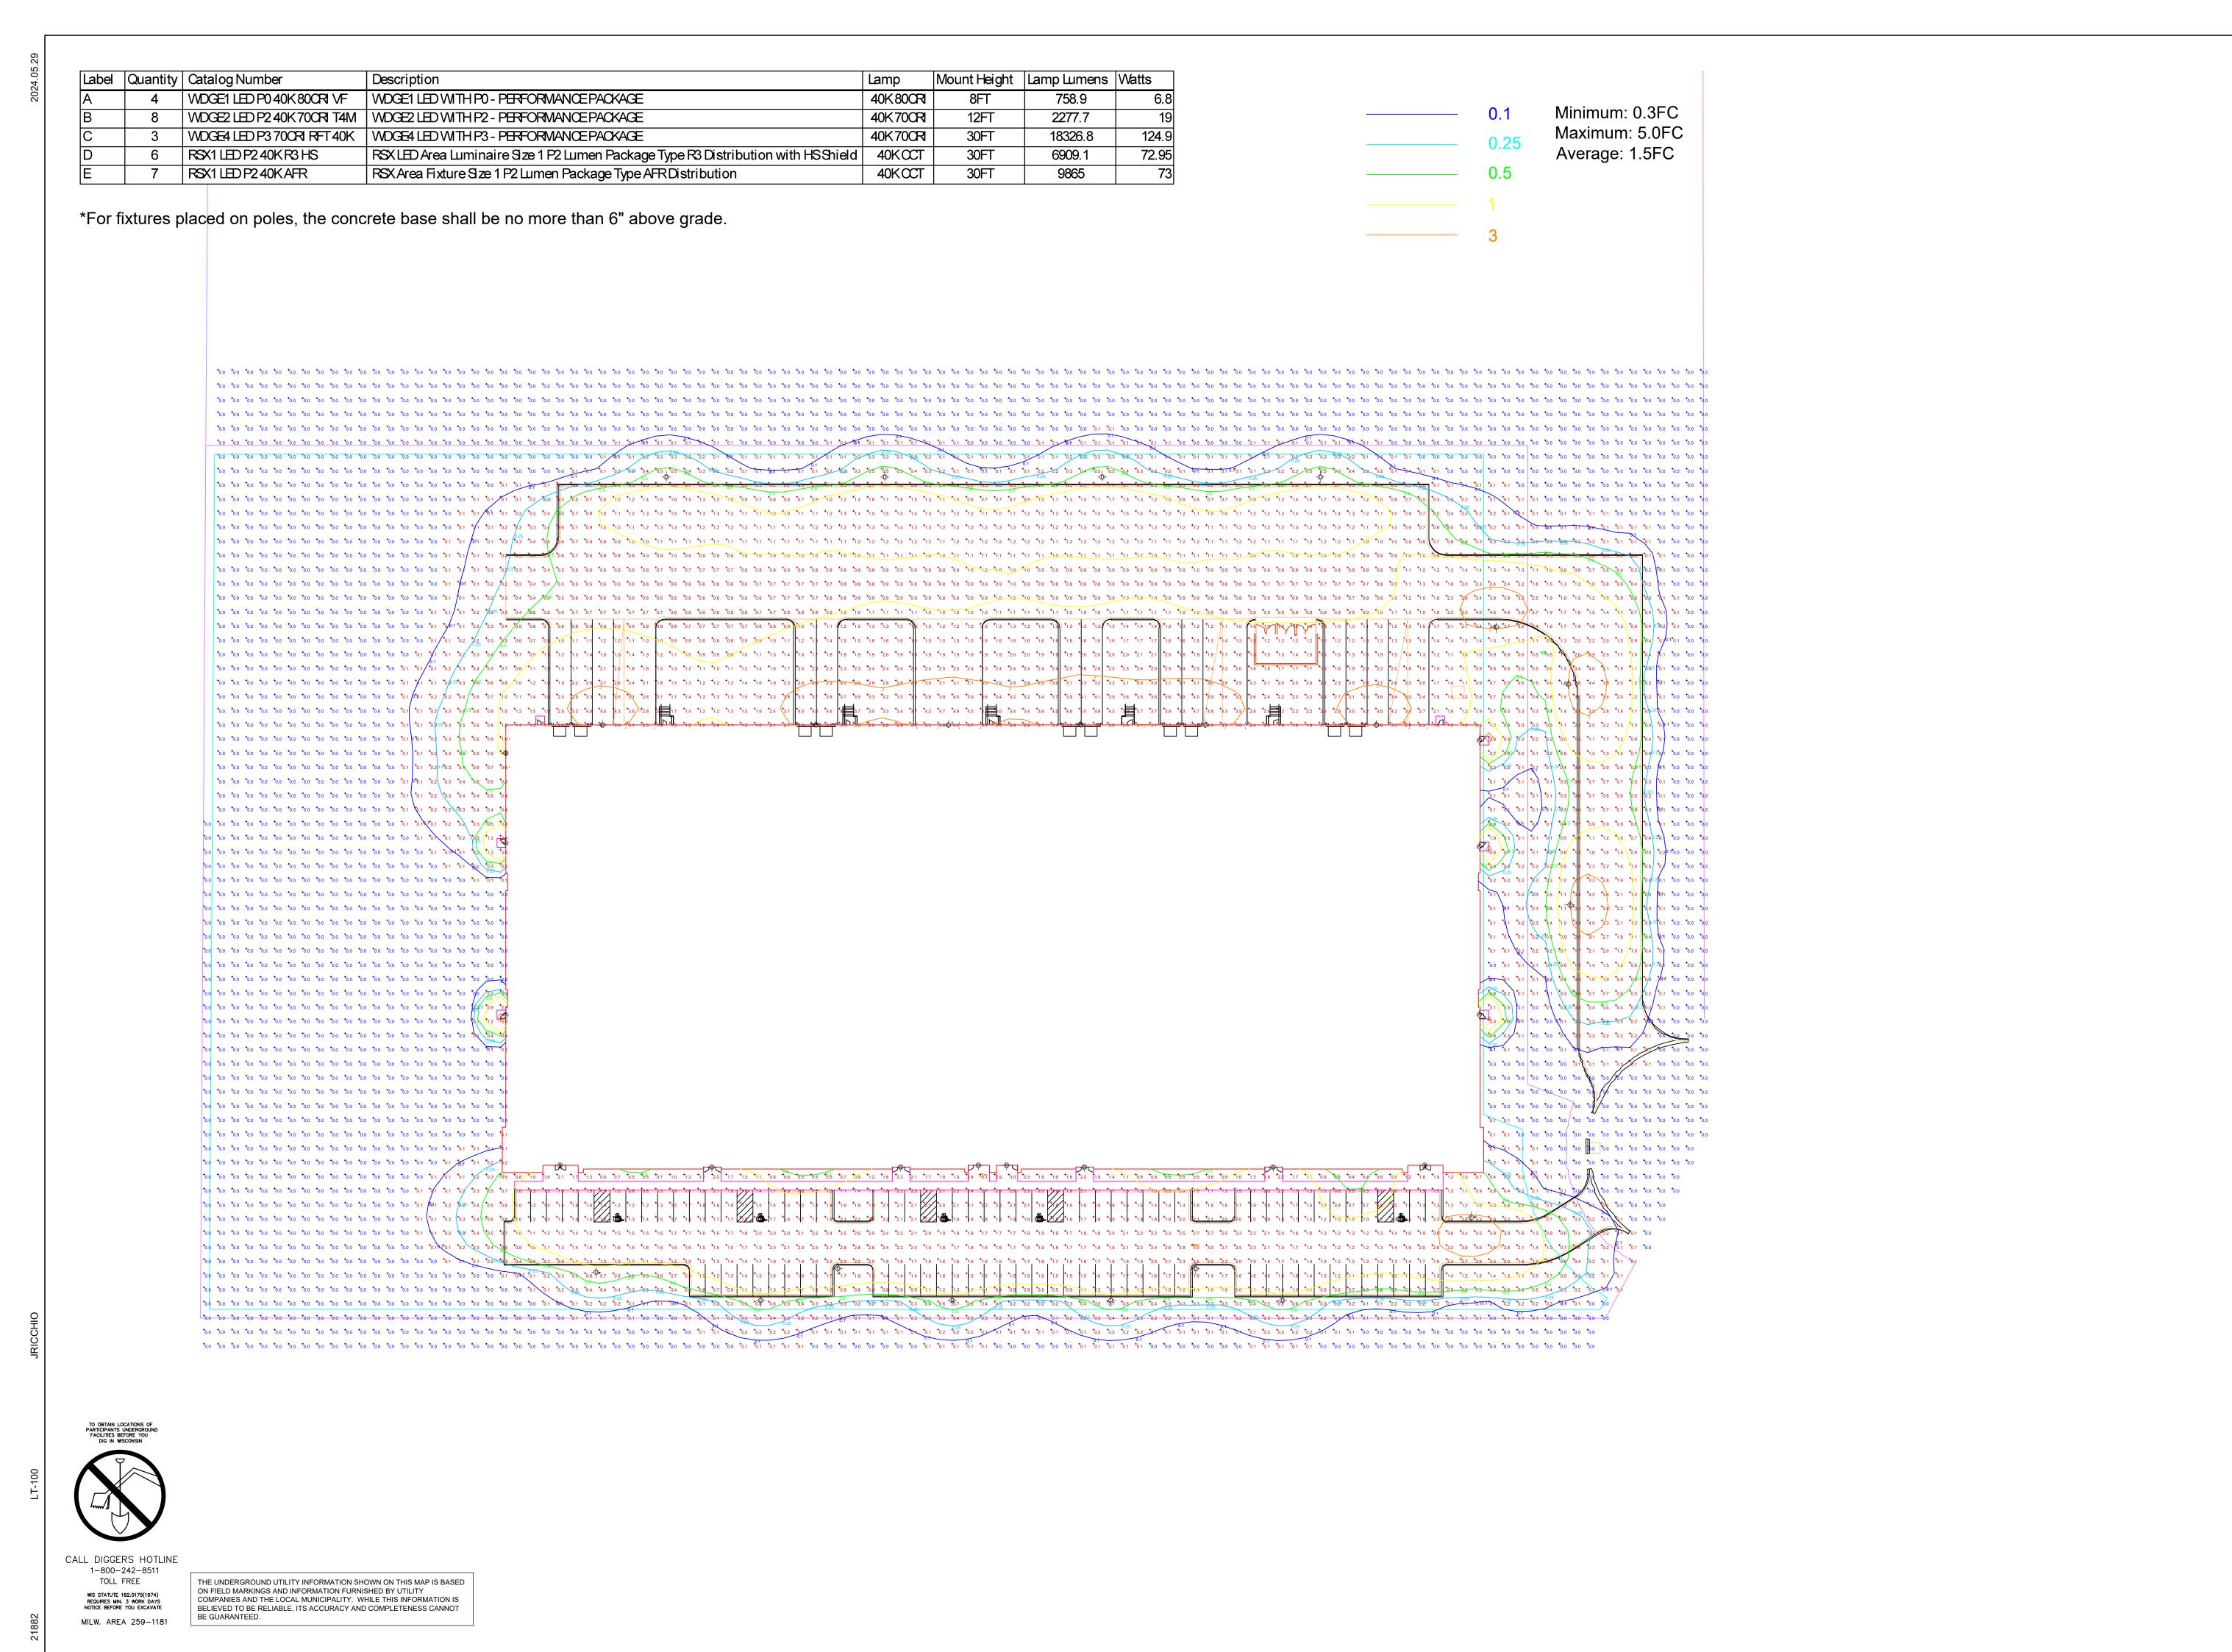

Single Source. Sound Solutions. GROUP www.thesigmagroup.com
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HIGHLANDS SITE X HLANDS COURT

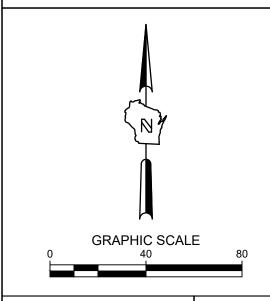HG

PRELIMINARY NOT FOR CONSTRUCTION

ISSUANCE	DATE
PLAN COMMISSION SUBMITTA DSPS SUBMITTAL	5/23/2024
VILLAGE RESUBMITTAL	5/29/2024
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PROJECT NO:	21882
DESIGN DATE:	
PLOT DATE:	2024.05.29
DRAWN BY:	JTR
CHECKED BY:	
APPROVED BY:	PJI
SHEET NO:	

LT-100

**PROJECT** TEAM

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TIMBERLAKE ENGINEERING 912 South Old Highway 63 Columbia, MO 65201

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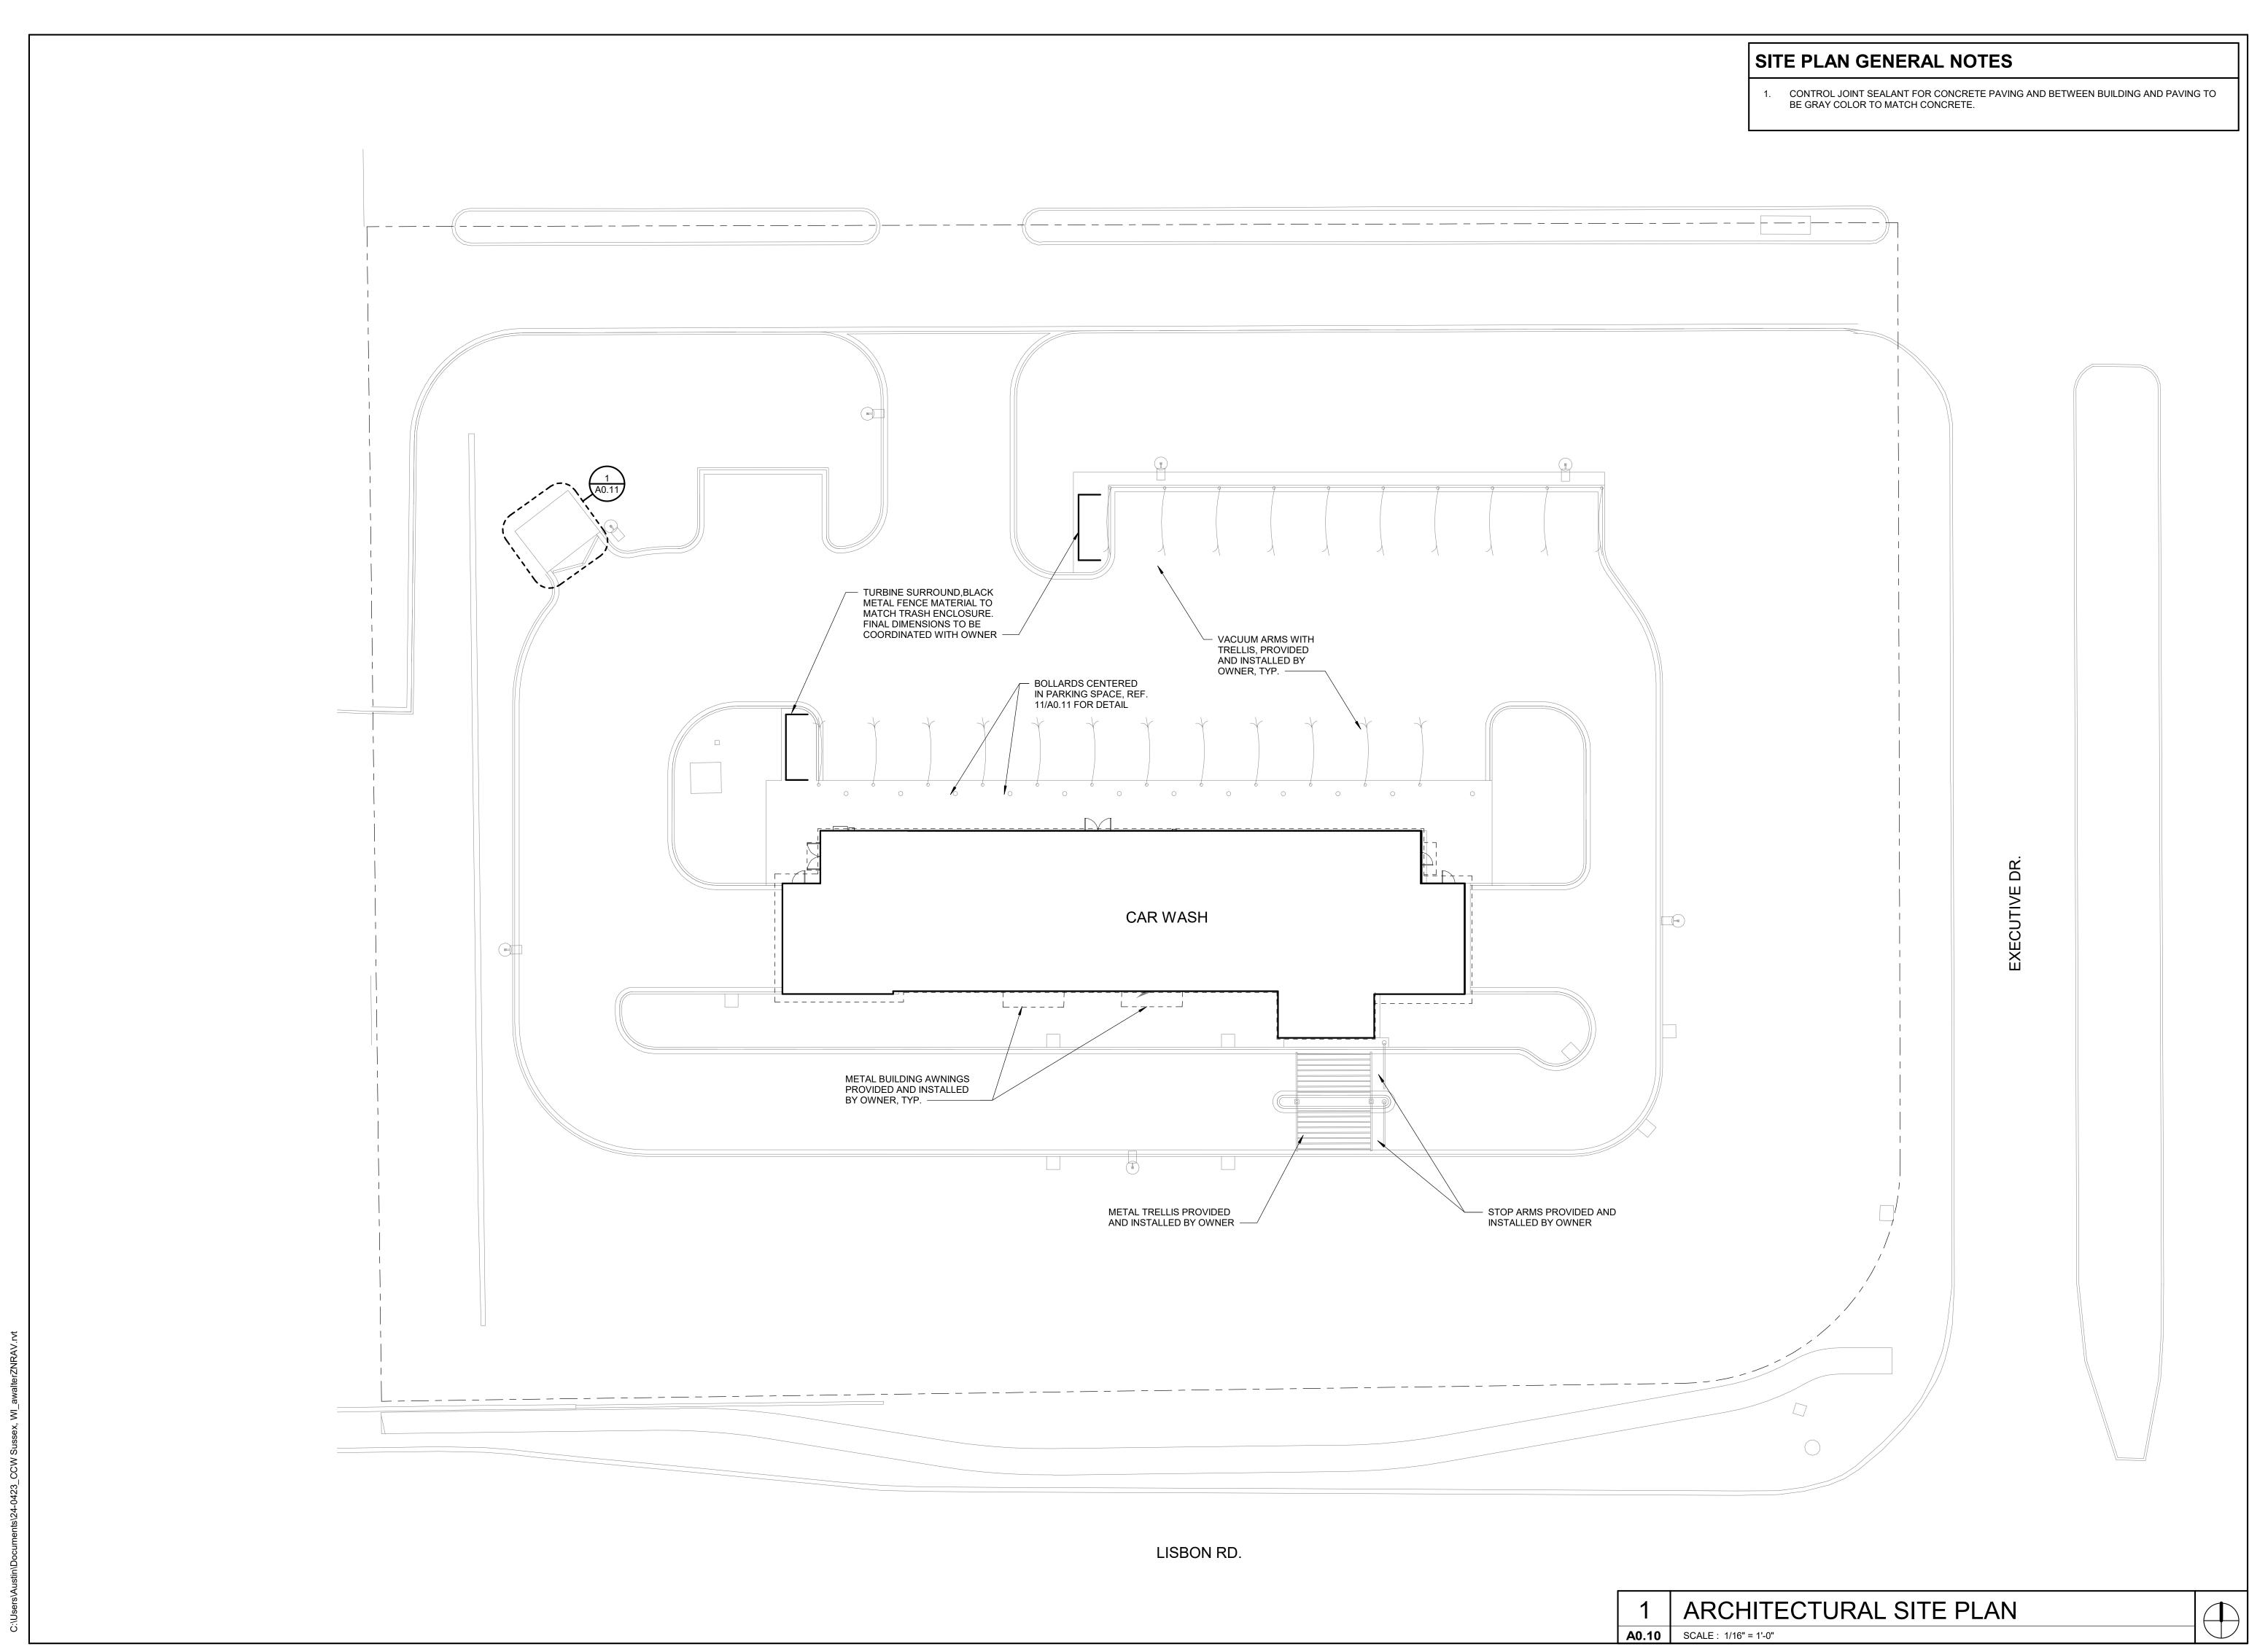
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STRUCTURAL





CLUB CAR WASH

W248N5221 Executive Dr. Sussex, WI 53089

Project No.: 20015.121

Issued For: PERMIT SET

REVISIONS

No. Date Description

\_\_\_\_\_

REGISTRATION



PROJECT TEAM

ARCHITECT FINKLE+WILLIAMS

CIVIL COCHRA

CIVIL COCHRAN ENGINEERING

LANDSCAPE COCHRAN

LANDSCAPE COCHRAN ENGINEERING

STRUCTURAL CROCKETT ENGINEERING

PLUMBING TIMBERLAKE ENGINEERING

MECHANICAL TIMBERLAKE ENGINEERING

ELECTRICAL TIMBERLAKE ENGINEERING

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FINKLE + WILLIAMS

ARCHITECTURE


8787 RENNER BLVD., SUITE 100 LENEXA, KANSAS 66219 913 .498.1550 www.finklewilliams.com

SHEET TITLE

ARCHITECTURAL SITE PLAN

SHEET NUMBER

A0.10

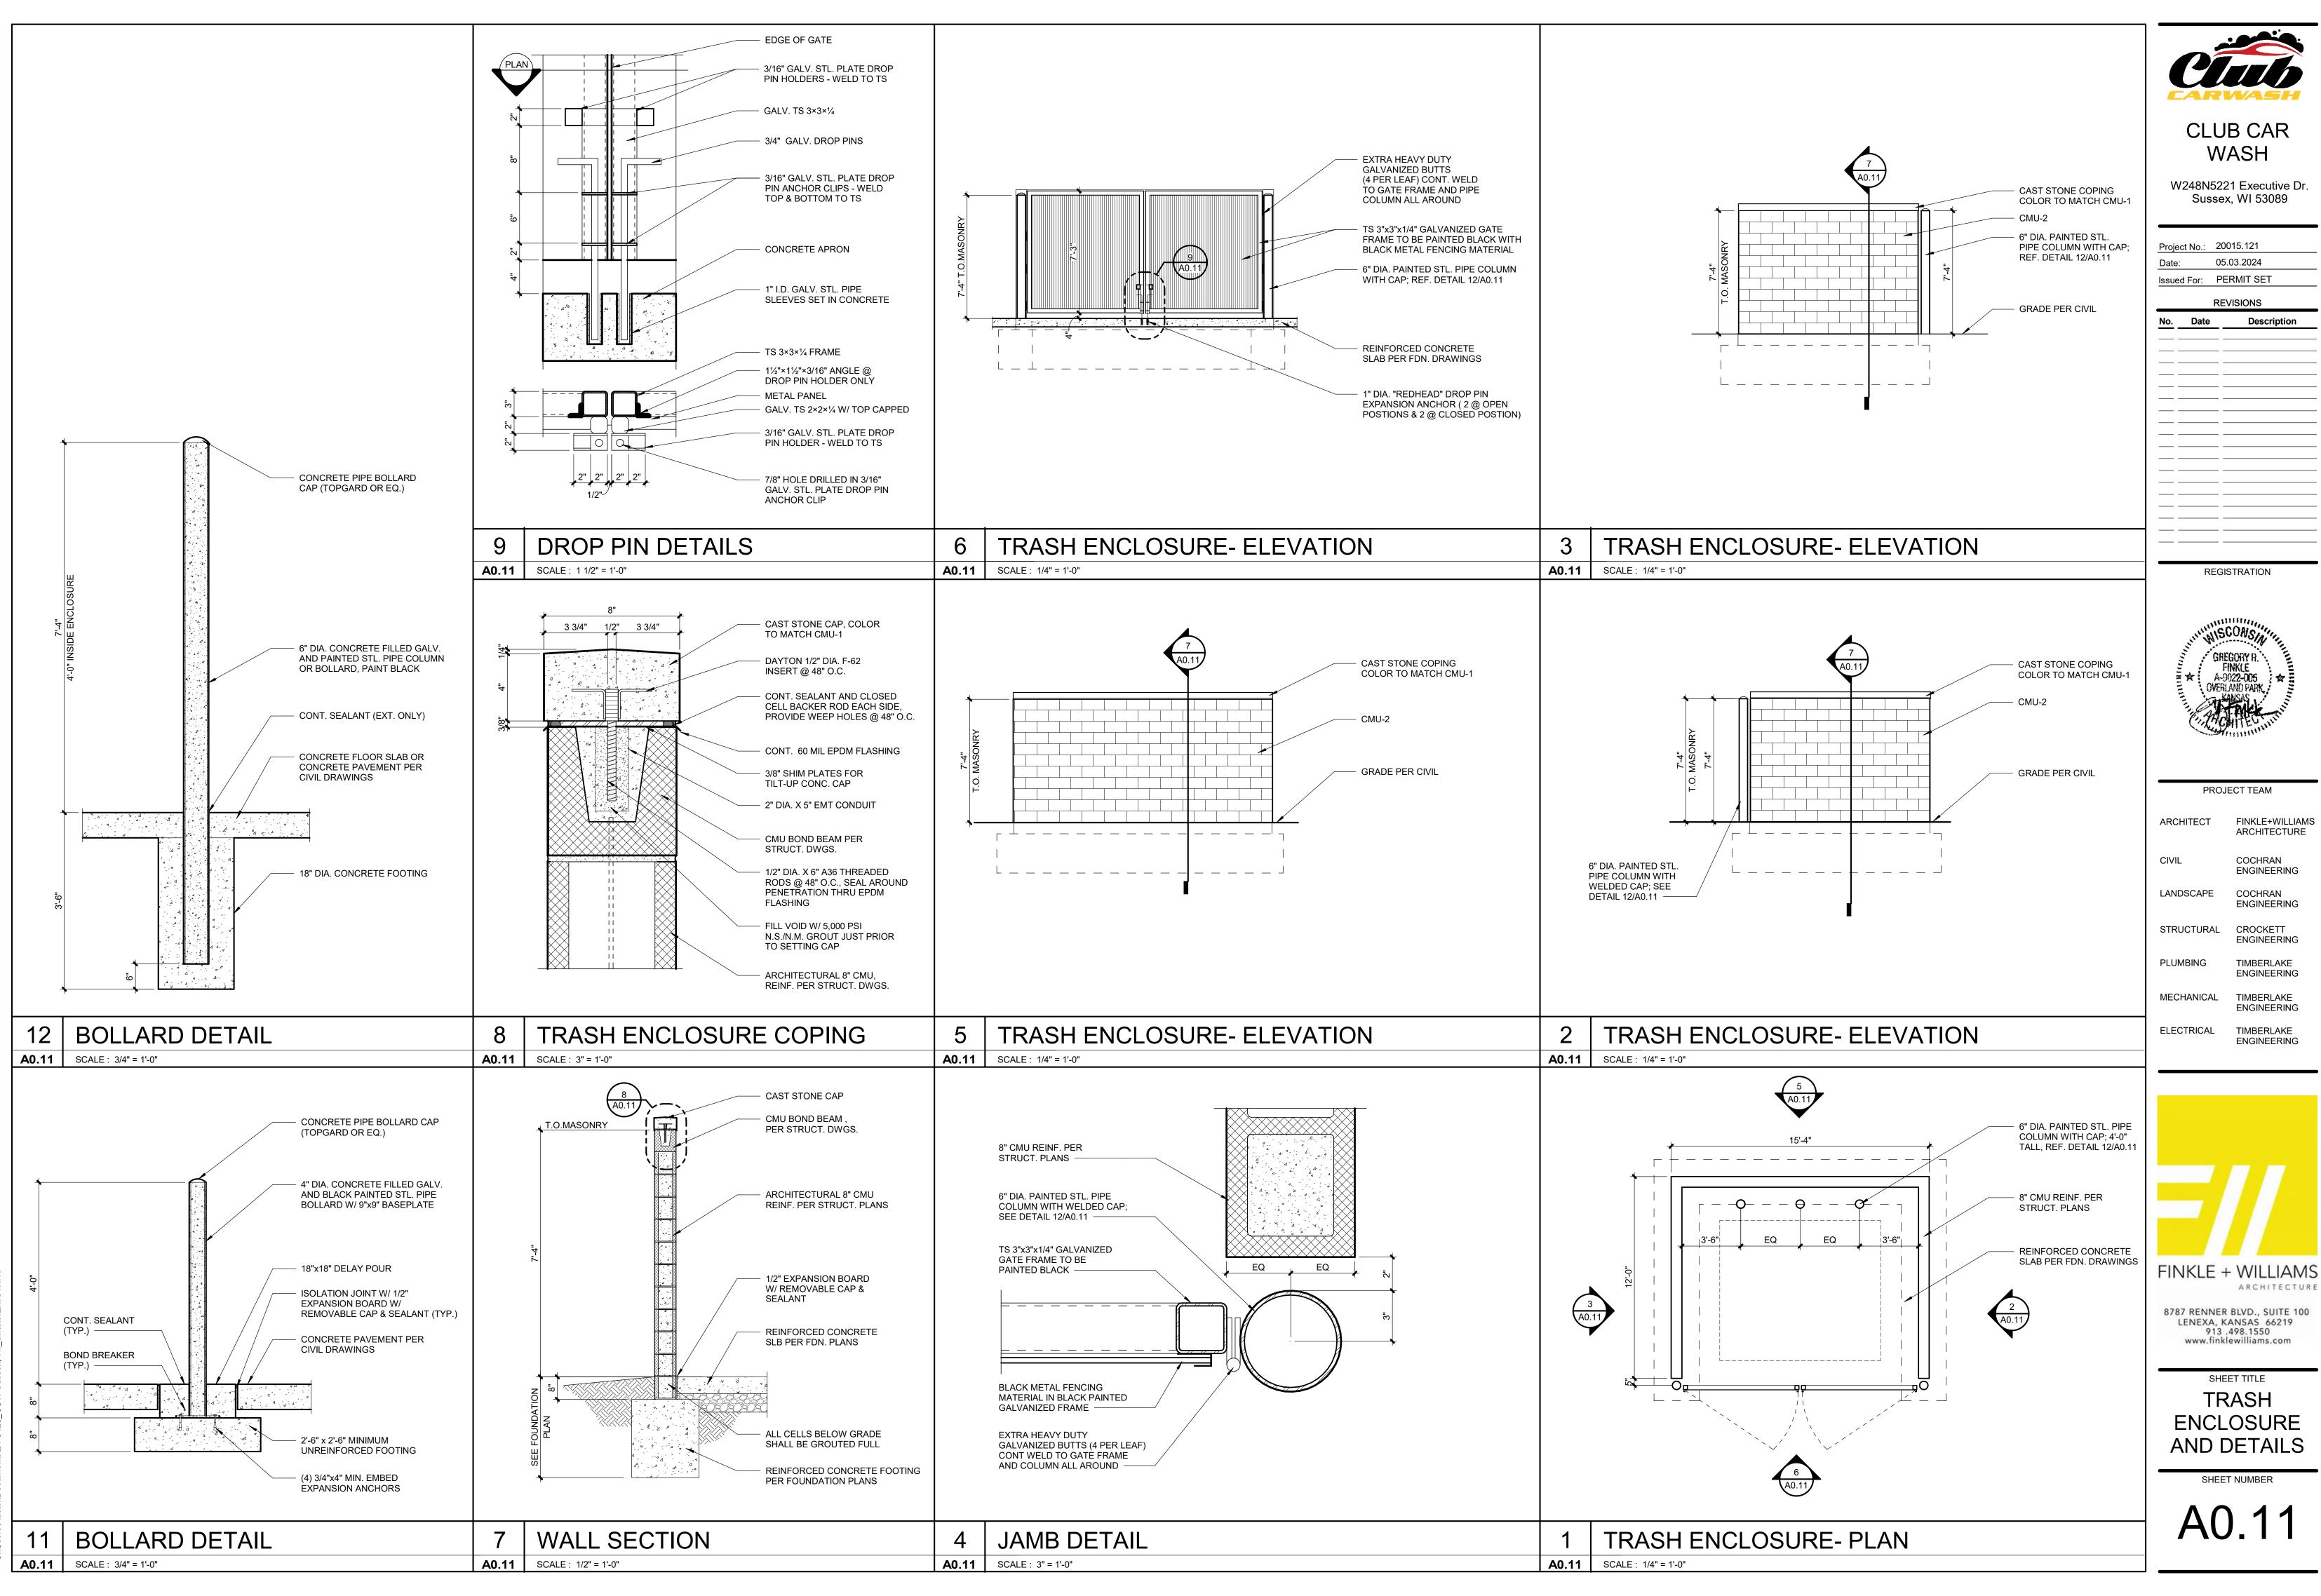



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STRUCTURAL CROCKETT **ENGINEERING** 

> **TIMBERLAKE ENGINEERING**

MECHANICAL **TIMBERLAKE** 

**ENGINEERING** 


**TIMBERLAKE** ENGINEERING

8787 RENNER BLVD., SUITE 100 LENEXA, KANSAS 66219 913 .498.1550 www.finklewilliams.com

SHEET TITLE

TRASH **ENCLOSURE** AND DETAILS

SHEET NUMBER

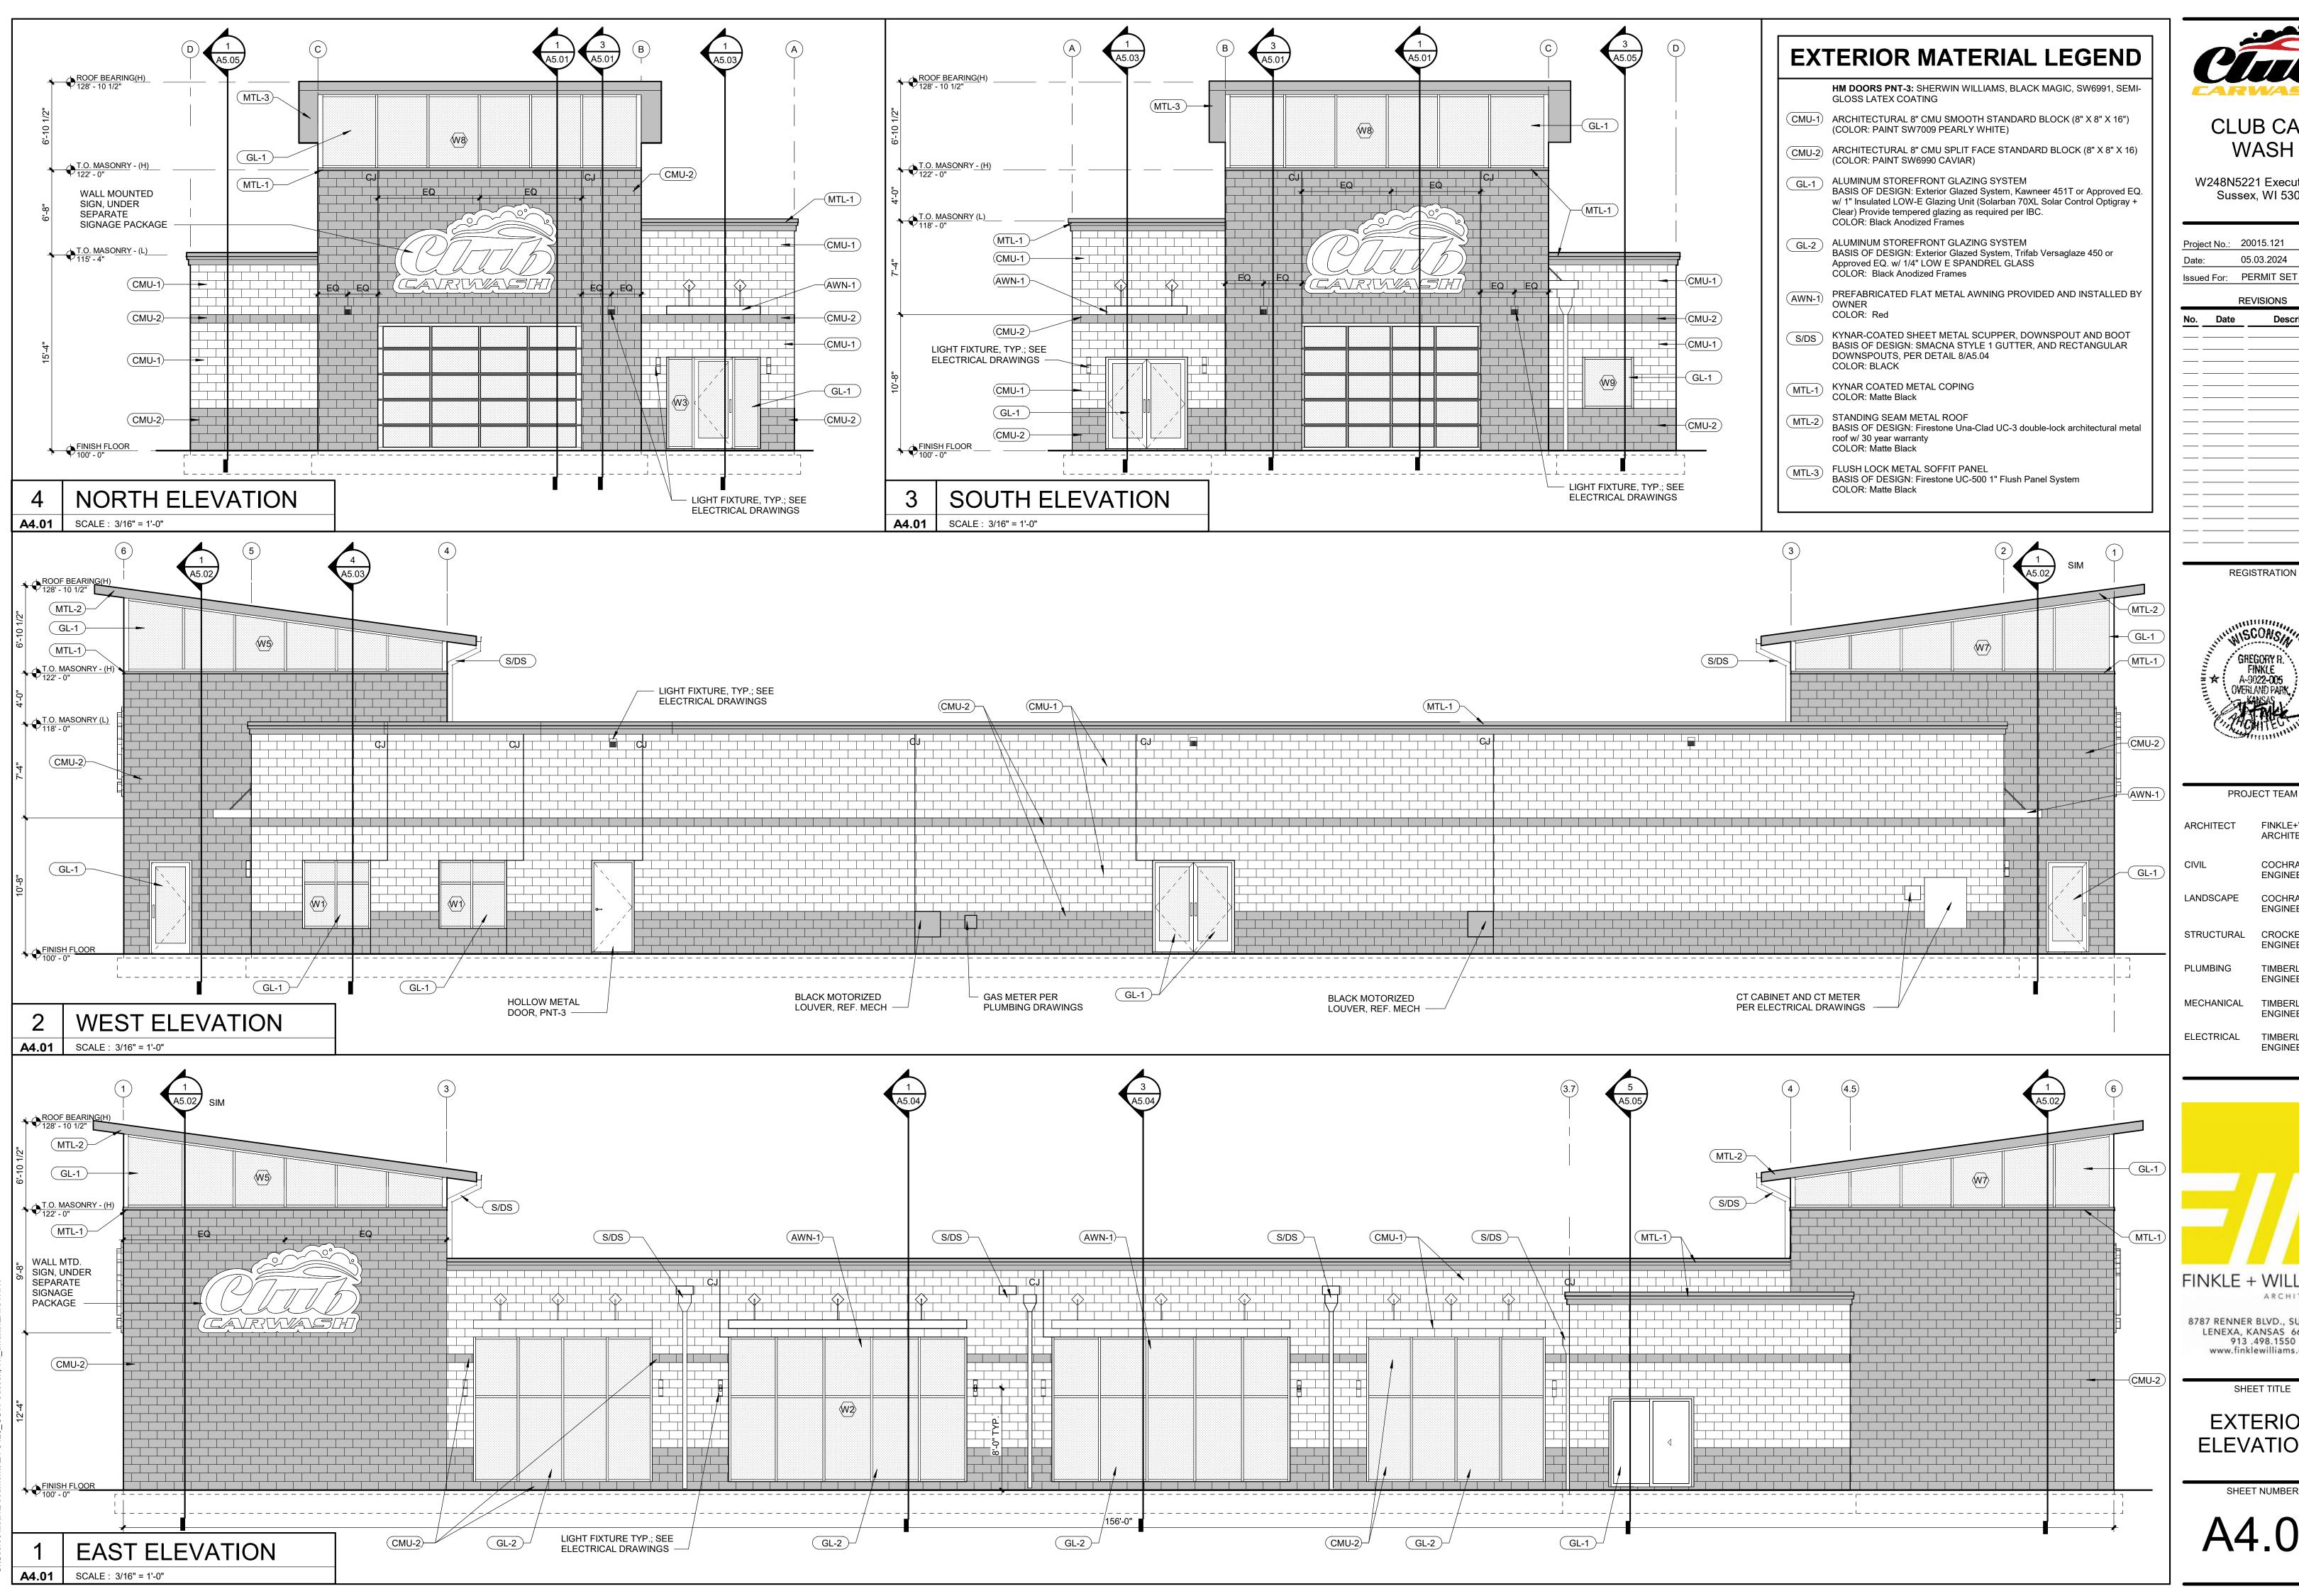

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ARCHITECTURE

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SHEET TITLE

**EXTERIOR ELEVATIONS** 

SHEET NUMBER














CLUB CAR WASH RENDERINGS

LISBEN ROAD - CTH "K'

# LANDSCAPE PLAN

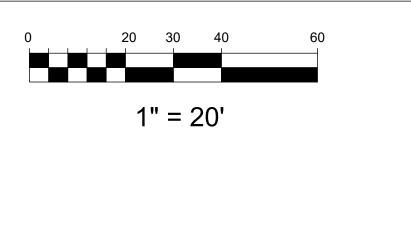

## **LANDSCAPE INSTALLATION NOTES:**

## GENERAL:

-Landscape contractor is responsible for coordinating work with general contractor to ensure the landscape scope of work doesn't interfere with existing or built conditions. They should note any discrepancies to the general contractor.

-Landscape contractor is responsible for verifying the location of underground utilities by calling their local utility marking service.

-All plant material should be inspected by Landscape Contractor prior to installation to determine overall appearance and condition. Plant material that is damaged or has clear signs of stress should be rejected.

-Quantities of material shown on plan take precedence over the specification list or legend.

-If plant substitutions are required, Landscape Contractor is responsible for submitting recommendations to the client or client's representative.

## D. 41. T. 1. 10

-When excavating for plant pits, any excess rock or building material should be removed an replaced with specified soil mix backfill.

-All plant tags should be removed from material by landscape contractor.

-All planting beds should receive a minimum 3" deep layer of shredded hardwood mulch, unless otherwise noted.

-Edge all beds with a spade cut edge unless otherwise noted.

-All backfill around plant material rootballs should receive a soil mix of 4 parts (pulverized) topsoil to 1 part fine, organic compost.

-All wire baskets and stakes should be removed during planting.

-Cut and remove top half of burlap around rootballs and cut and remove any twine around trunk or root flare.

-All stakes and guy wires and tree wrap are to be removed no more than 1 year after installation.

PLANT S	CHEDUL	E	
TREES	QTY	COMMON NAME / BOTANICAL NAME	SIZE
PLA	9	Plantanus x acerifolia 'London Planetree'	2.5"
GYM	7	Gymnocladus dioicus 'Kentucky Coffeetree'	2.5"
ARB	20	Thuja occidentalis 'Emerald Green'	6'
	•		•
SHRUBS	QTY	COMMON NAME / BOTANICAL NAME	SIZE
JUN	53	Juniperus x pfitzeriana 'Sea Green'	36"
VIB	33	Viburnum carlesii 'Korean Spice'	36"
BUX	39	Buxus x 'Green Velvet'	18"
SPI	19	Spirea japonica	18"
PAN	41	Panicum virgatum 'Heavy Metal'	#5

## LANDSCAPE REQUIREMENTS:

All public off-street parking areas which serve five (5) vehicles or more shall be provided with accessory landscape areas totaling not less than fifteen (15) percent.


- Parking Sq. Ft. = 8,257.72 x 15% = 1,238.65


- Parking Sq. Ft. = 8,257.72 x 15% = 1,238 - Total landscape area provided = 1,904

Street Trees: One (1) tree shall be planted for each forty (40) feet of frontage.


Total street frontage592' / 40'


= 592' = 15 Trees 16 TREES PROVIDED

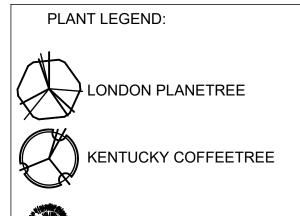

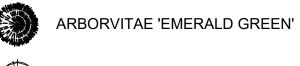



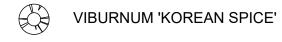

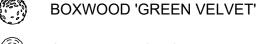

SPIREA, JAPONICA

SWITCH GRASS 'HEAVY METAL'

elevate outdoor

Elevate Outdoor LLC. 1112 Bryan Road O'Fallon, MO 63366 636-946-1313 www.elevate-outdoor.com

> Club Car Wash Executive Drive & Lisbon Road Sussex, Wisconsin 53089

This drawing is conceptual and is only to be used as a guide for construction. The completed project may differ from this plan in appearance and dimension.

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Drawing Completed: 3-19-2024 4-22-2024

andscape Plan